# PROJECT SUMMARY

HORIZONTAL DATUM: NAD 83

**VERTICAL DATUM: NAVD 88** 

BENCHMARK: XX

NPDES PERMIT: XX

SCDHEC WATER PERMIT: XX

SCDHEC SEWER PERMIT: XX

PARCEL PIN #:

383-00-00-0350

**CURRENT ZONING:** PROPOSED LAND USE: TOTAL PROJECT AREA = LAND DISTURBANCE AREA =

**PARKING** 16.06 ACRES 12.00 ACRES

PUD

PARKING PROVIDED:

396 STALLS 386 STALLS STANDARD =

COMPACT = HANDICAPPED = 0 STALLS (0% OF TOTAL)

VAN ACCESSIBLE =

0 STALLS 10 STALLS


WETLAND AREA = POND AREA =

NONE 0.55 ACRES H17-N138-MJ FOR

COASTAL CAROLINA UNIVERSITY

B&C Bldg. (BBB) Parking Complex;

SITE LOCATION HUSTED RD. HORRY COUNTY, SC

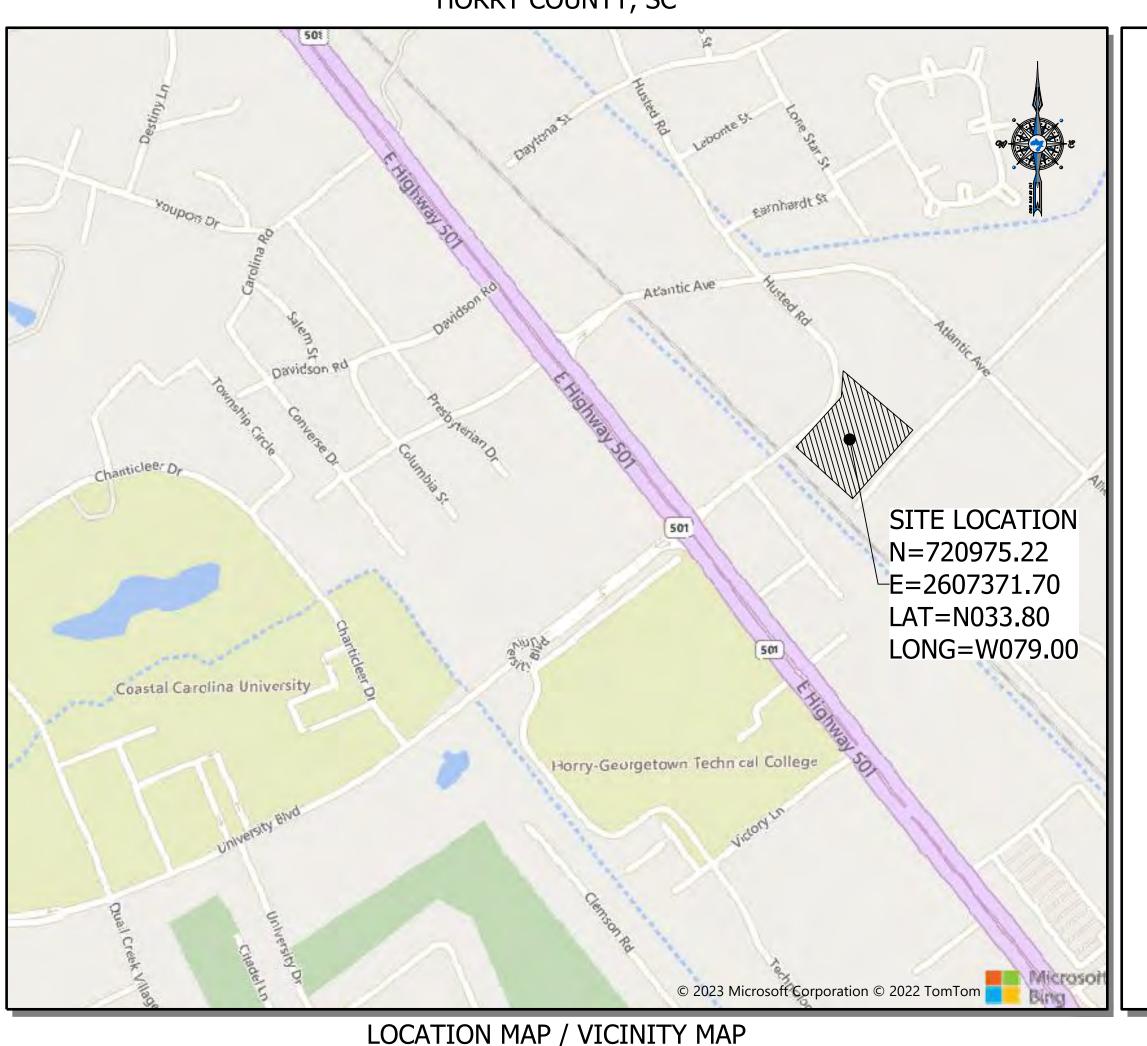

SHEET	DESCRIPTION
C1.0	COVER
C2.0	GENERAL NOTES
C3.0	EXISTING CONDITIONS
C4.0	SITE PLAN
C5.0	GRADING PLAN
C6.0	DRAINAGE PLAN
C6.1	DRAINAGE PROFILES
C7.0	EROSION CONTROL PLAN - 1
C7.1	EROSION CONTROL PLAN - 2
C7.2	EROSION CONTROL PLAN - 3
C8.0	DETAILS - 1
C8.1	DETAILS - 2
C8.2	DETAILS - 3
L1.0	LSCP - L1
L2.0	LSCP - L2

SHEET INDEX

THIS PROPERTY IS LOCATED IN FLOOD ZONE "X" AS SCALED FROM F.I.R.M. No. 45051C0542 K, DATED DEC. 16, 2021, THIS PLAT IS NOT THE BASIS FOR FLOOD ZONE DETERMINATION OR FLOOD ZONE RELATED ISSUES.

CONTRACTOR SHALL BE KNOWLEDGEABLE WITH LOCAL, CITY, COUNTY, STATE, AND FEDERAL REGULATIONS AS THEY MAY PERTAIN TO THIS PROJECT AND SHALL ADHERE TO THESE REGULATIONS.

INFORMATION REGARDING THE PRESENCE, SIZE, CHARACTER, AND LOCATION OF ANY UNDERGROUND UTILITY AND/OR STRUCTURE SHOWN ON THIS PLAN IS APPROXIMATE. IT IS THE CONTRACTOR'S RESPONSIBILITY TO HAVE ALL UNDERGROUND UTILITIES LOCATED.

SCALE 1'' = 500'

NOTE:

NO COVENANTS OR RESTRICTIONS EXIST WHICH MAY CONFLICT WITH THE PROPOSED USES.

- LIVE OAKS 24" DBH OR GREATER EXIST ON SITE.
- LIGHT FIXTURES SHALL BE FULL-CUTOFF AND MEET ILLUMINATING ENGINEERING SOCIETY OF NORTH AMERICA (IESNA) CRITERIA. LIGHTING SHALL BE AIMED STRAIGHT DOWN.
- LIGHTING SHALL NOT PRODUCE ILLUMINATION THAT EXCEEDS 1 FOOTCANDLE BEYOND ANY RESIDENTIAL LOT

LINE.

- ALL PROPOSED SIGNAGE WILL BE SUBMITTED SEPARATELY
- 6. NO DUMPSTER ON SITE









			//////////////////////////////////////	ii.		
COVER	B&C BLDG. (BBB) PARKING COMPLEX;	H17-N138-MJ	PREPARED FOR:	COASTAL CAROLINA UNIVERSITY	PO BOX 261954	MR. MARK AVANT, FE, LEED AP
$\frac{1}{2}$	3) P	7-N				
	B&C BLDG. (BBB	H17		PLANS FOR	PERMITTING	
JOE	B NO	):			22	186

DESIGNED BY: C.BARRET CHECKED BY: APPROVED BY: SHEET NUMBER

1" = 500

SCALE:



# SITE WORK

- 1. EXISTING CONTOURS AND ELEVATIONS AS SHOWN ON THIS PLAN WERE TAKEN FROM A FIELD TOPOGRAPHIC SURVEY PREPARED BY DEVELOPMENT RESOURCE GROUP,LLC, CONTRACTOR SHALL CONTACT AND REFERENCE SAME BENCHMARK AS USED BY SURVEYOR.
- 2. BEFORE ANY EARTHWORK IS DONE, THE CONTRACTOR SHALL STAKE OUT AND FLAG THE CLEARING LIMITS, TREES TO BE SAVED & OTHER ITEMS ESTABLISHED BY THE PLANS. THE CONTRACTOR SHALL PROVIDE ALL NECESSARY ENGINEERING AND SURVEYING FOR LINE AND GRADE CONTROL POINTS RELATED TO EARTHWORK.
- 3. CLEARING LIMITS SHALL BE, AT A MINIMUM, THE CLEARING REQUIRED IN ORDER TO FACILITATE THE WORK, OR TO PROVIDE FOR ADDITIONAL UTILITIES OR EASEMENTS AND SHALL BE THE RESPONSIBILITY OF THE CONTRACTOR.
- 4. NO TREE SHALL BE REMOVED OR DAMAGED WITHOUT PRIOR AUTHORIZATION OF THE OWNER OR OWNER'S REPRESENTATIVE. EXISTING TREES TO BE SAVED, AS SHOWN ON THE DRAWINGS, SHALL BE PRESERVED.
- 5. ALL BACKFILL AND FILL SOILS SHOULD BE NON-PLASTIC AND GRANULAR IN NATURE. SOILS SHOULD BE PLACED IN MAXIMUM EIGHT (8.0) INCH COMPACTED LIFTS. EACH
- LIFT SHALL BE COMPACTED TO AT LEAST NINETY-FIVE PERCENT (95%) OF THE SOIL'S MODIFIED PROCTOR MAXIMUM DRY DENSITY (ASTM D1557).

  6. CONTRACTOR IS RESPONSIBLE FOR PROPERLY DISPOSING OF UNSUITABLE MATERIAL OFF SITE. ALL SUITABLE MATERIAL SHALL BE STOCKPILED AT OWNERS DIRECTION.
- 7. ALL EXCAVATION IS UNCLASSIFIED AND SHALL INCLUDE ALL MATERIALS ENCOUNTERED. UNUSABLE EXCAVATED MATERIAL AND ALL WASTE RESULTING FROM SITE CLEARING AND GRUBBING SHALL BE DISPOSED OF OFF SITE BY THE CONTRACTOR AT THEIR EXPENSE UNLESS INSTRUCTED OTHERWISE BY THE ENGINEER.
- 8. CONTRACTOR SHALL BE SOLELY RESPONSIBLE FOR ALL GEOTECHNICAL ENGINEERING CONCERNING THE SITE, HOMESITE LOCATION, COMPACTION, SOILS AND COMPACTION TESTING AND HOMESITE SUITABILITY.

## DRAINAGE

- 1. ALL MATERIALS AND WORKMANSHIP ARE TO CONFORM TO THE REQUIREMENTS SET FORTH BY HORRY COUNTY, SCDOT AND SC DHEC.
- 2. IF AN ITEM IS NOT COVERED BY THESE PLANS, THEN HORRY COUNTY AND SCDOT AND SC DHEC GENERAL SPECIFICATIONS COVERING SUCH ITEMS SHALL APPLY.
- 3. ALL DRAINAGE PIPE SHALL BE RCP, CLASS III UNLESS OTHERWISE SPECIFIED
- 4. FOR PIPE JOINTS, AND DRAINAGE STRUCTURES, CONTRACTOR SHALL USE TYPE M OR S MORTAR
- 5. ALL DRAINAGE STRUCTURES SHALL HAVE A MINIMUM INSIDE DIMENSION OF 3' x 3'
- 6. ALL DRAINAGE STRUCTURES GREATER THAN 6' IN DEPTH SHALL UTILIZE STEPS.
- ALL PIPE LENGTHS ARE MEASURED FROM CENTER OF STRUCTURE TO CENTER OF STRUCTURE.

# WATER AND SEWER

- 1. ALL MATERIALS AND WORKMANSHIP ARE TO CONFORM TO THE REQUIREMENTS SET FORTH BY HORRY COUNTY AND SC DHEC.
- 2. IF AN ITEM IS NOT COVERED BY THESE PLANS, THEN HORRY COUNTY AND SC DHEC GENERAL SPECIFICATIONS COVERING SUCH ITEMS SHALL APPLY.
- . WATER MAINS SHALL BE MINIMUM, C-900, DR18 PVC PIPE, BLUE IN COLOR.
- 4. HYDRANTS SHALL BE MUELLER SUPER CENTURION A423 (4 1/2" MAIN VALVE).
- 5. SEWER PIPE SHALL BE MINIMUM, SDR 35 PVC PIPE, GREEN IN COLOR.
- 6. THE CONTRACTOR SHALL BE RESPONSIBLE FOR PROVIDING RECORD DRAWINGS TO THE ENGINEER SHOWING THE LOCATION OF WATER INFRASTRUCTURE IN STATE PLANE COORDINATES AND ANY DEVIATIONS FROM PLANS MADE DURING CONSTRUCTION. THE ENGINEER WILL PROVIDE RECORD PLANS TO HORRY COUNTY.
- 7. THE SITE UTILITY CONTRACTOR SHALL PROVIDE ALL MATERIALS AND APPURTENANCES NECESSARY FOR COMPLETE INSTALLATION OF THE UTILITIES. ALL PUBLIC PIPE, STRUCTURES, AND FITTINGS SHALL BE INSPECTED BY HORRY COUNTY INSPECTOR PRIOR TO BEING COVERED. THE INSPECTOR MUST ALSO BE PRESENT DURING DISINFECTION AND PRESSURE TESTING OF ALL MAINS. THE CONTRACTOR'S BID PRICE SHALL INCLUDE ALL TESTING AND INSPECTION FEES.
- 8. WATER MAINS SHALL HAVE A MINIMUM COVER OF 36" BELOW PROPOSED FINISHED GRADE.
- 9. ALL UNDERGROUND UTILITIES AND FIRE HYDRANTS MUST BE FUNCTIONALLY APPROVED PRIOR TO BUILDING CONSTRUCTION
- 10. IN NO SUCH CASE SHALL SEWER SLOPES BE LESS THAN INDICATED ON THESE PLANS.

### DAVING

- 1. ALL CONSTRUCTION SHALL BE IN ACCORDANCE WITH THESE PLANS SCDOT STANDARD SPECIFICATIONS, LATEST EDITION, HORRY COUNTY SPECIFICATIONS, AND GEOTECHNICAL REPORT (WHEN PROVIDED).
- 2. UPON COMPLETION OF PAVING, CONTRACTOR SHALL BE RESPONSIBLE FOR PROVIDING PAVEMENT CORE DATA AS REQUESTED BY HORRY COUNTY OR THE ENGINEER.
- 3. PRIME COAT AND TACK COAT APPLICATION TO BE IN ACCORDANCE WITH SCDOT STANDARD SPECIFICATIONS.
- 4. ALL SIGNS, PAVEMENT MARKINGS, AND OTHER TRAFFIC CONTROL DEVICES SHALL CONFORM TO THE SCDOT STANDARDS/FOR ROADWAY CONSTRUCTION AND THE MUTCD FOR HIGHWAY CONSTRUCTION.
- 5. UNLESS OTHERWISE DIRECTED, PAVEMENT MARKINGS SHALL BE PAINT OR AS DIRECTED BY THE OWNER.
- ALL STOP BARS AND ARROWS ARE TO BE THERMOPLASTIC.
- SAW CUTS ON EXISTING PAVEMENT FOR PATCHING SHALL HAVE A TYPICAL MINIMUM WIDTH OF 24 INCHES UNLESS OTHERWISE DIRECTED BY THE ENGINEER.



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B&C BLDG. (BBB) PARKING COMPLE
H17-N138-MJ
PLANS FOR

COASTAL CAROLINA UNIVERSITY

JOB NO: 22186

SCALE: ######

DESIGNED BY: C.BARRETT


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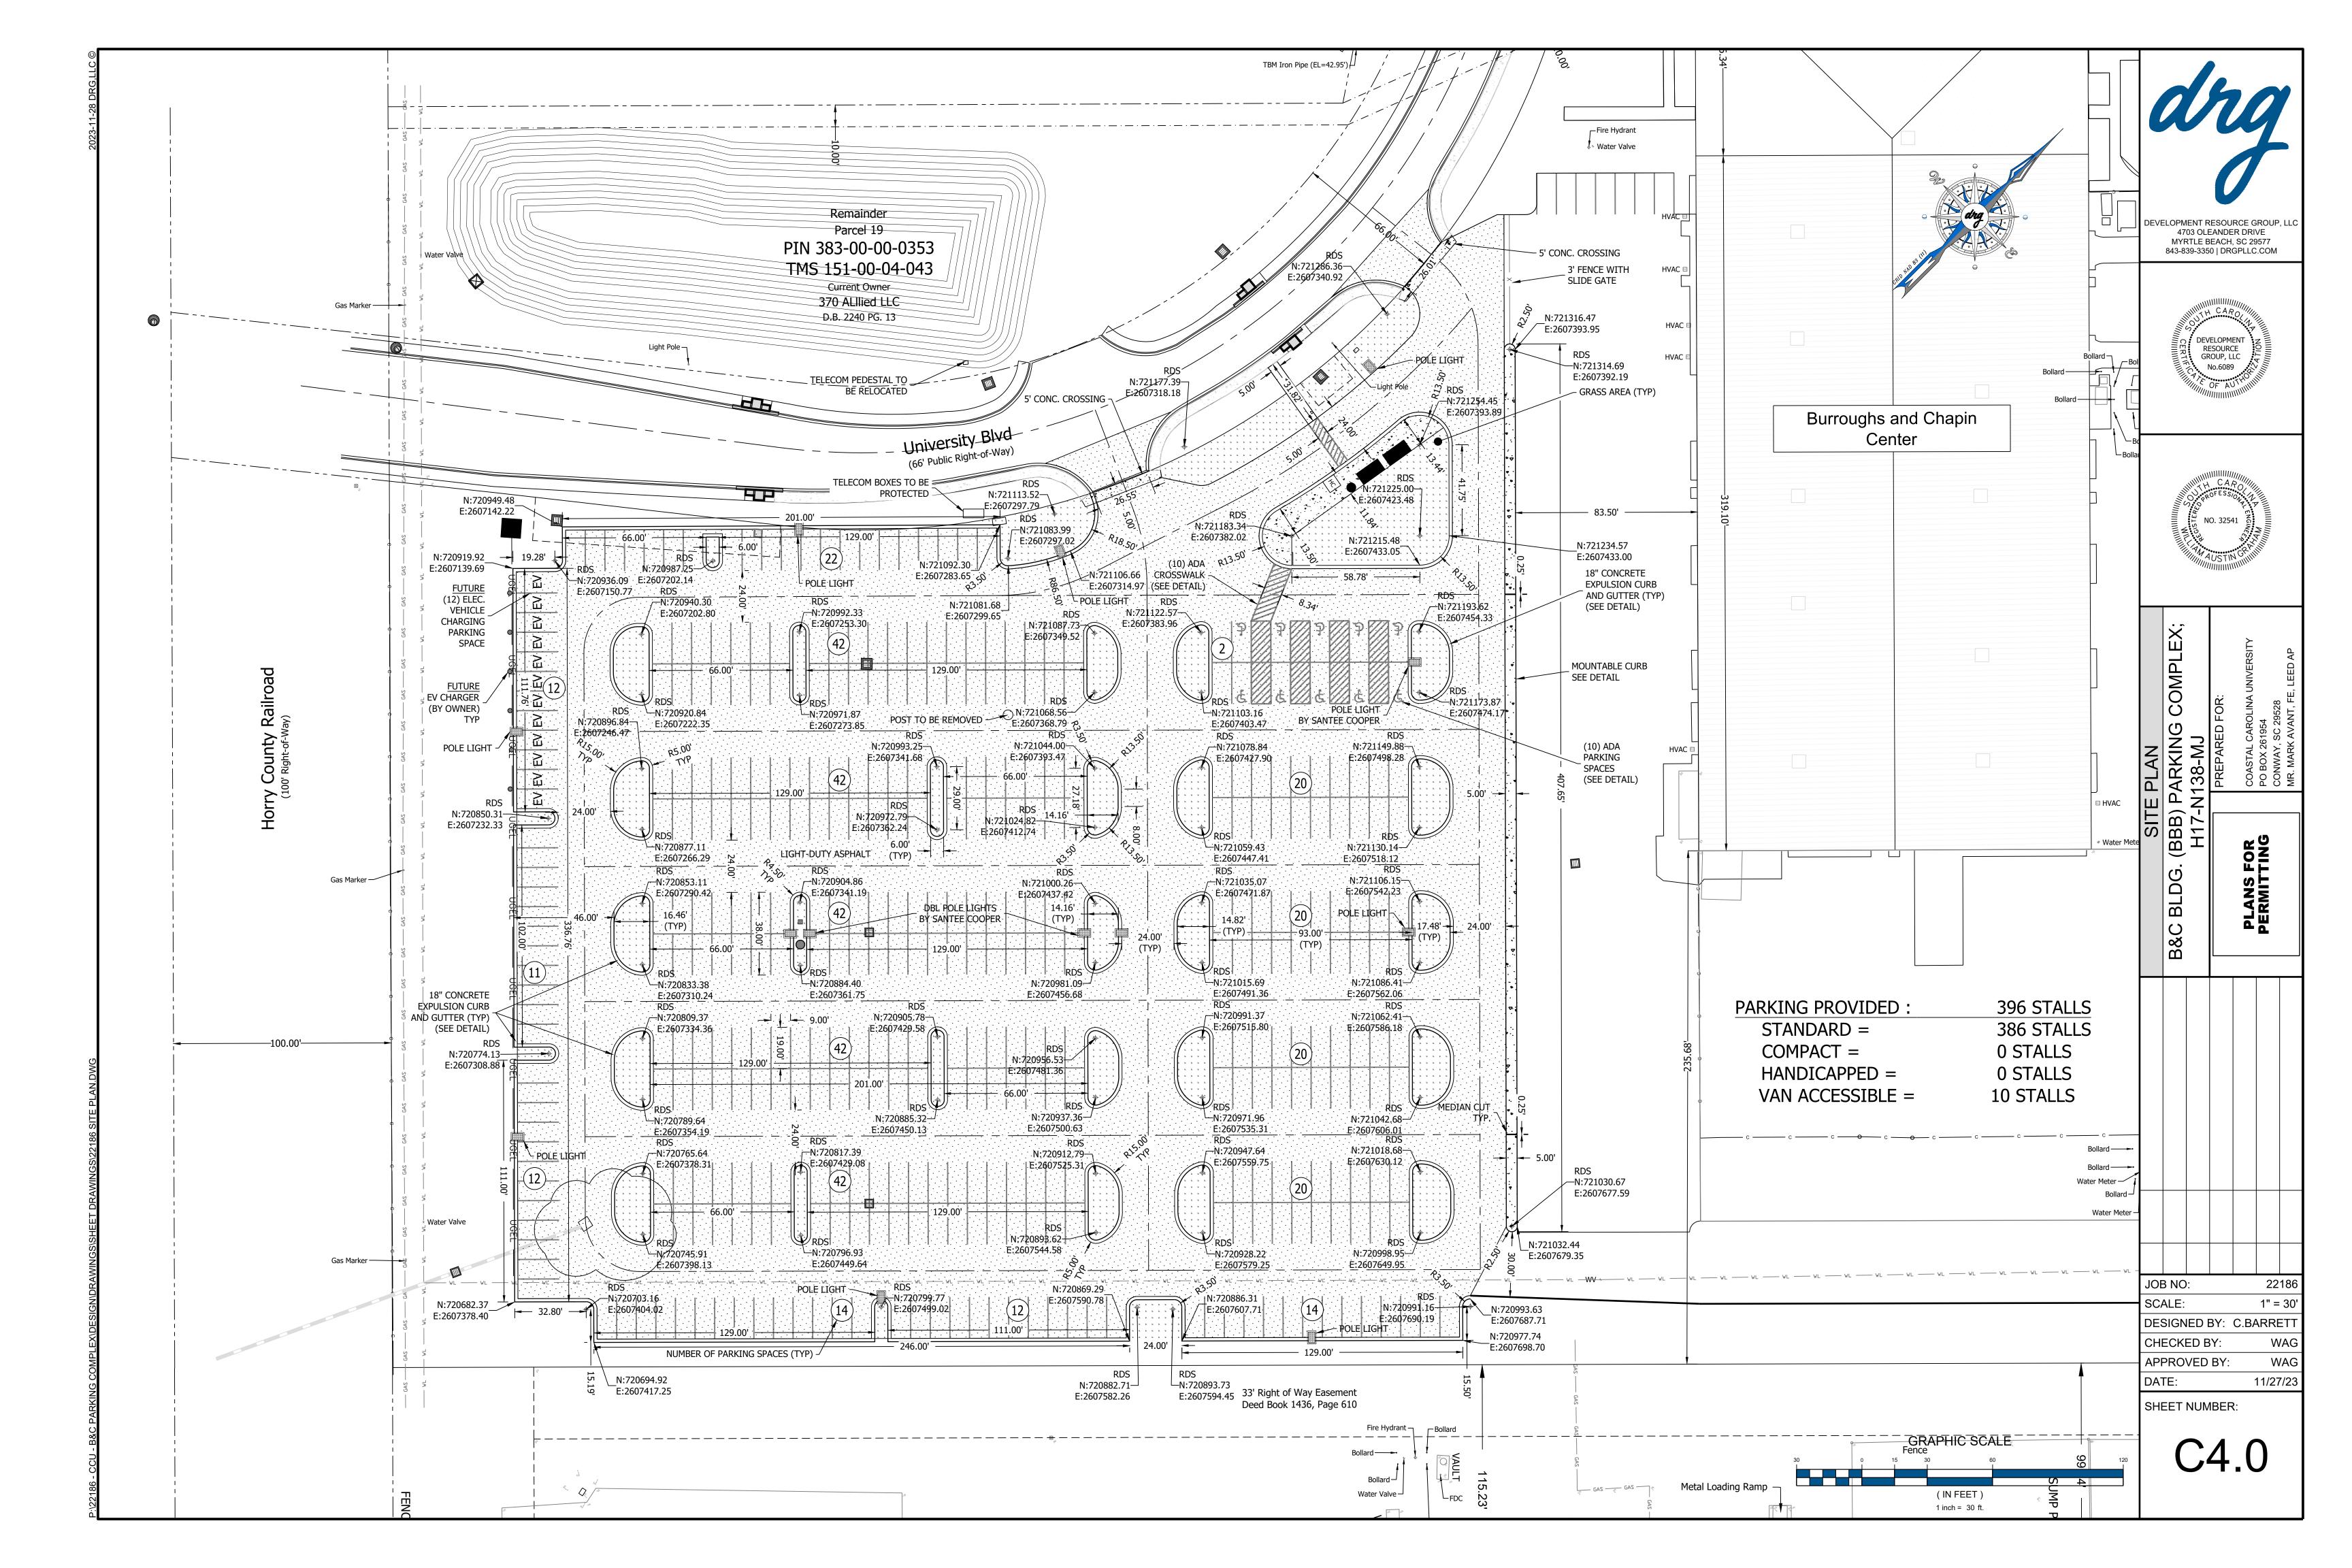
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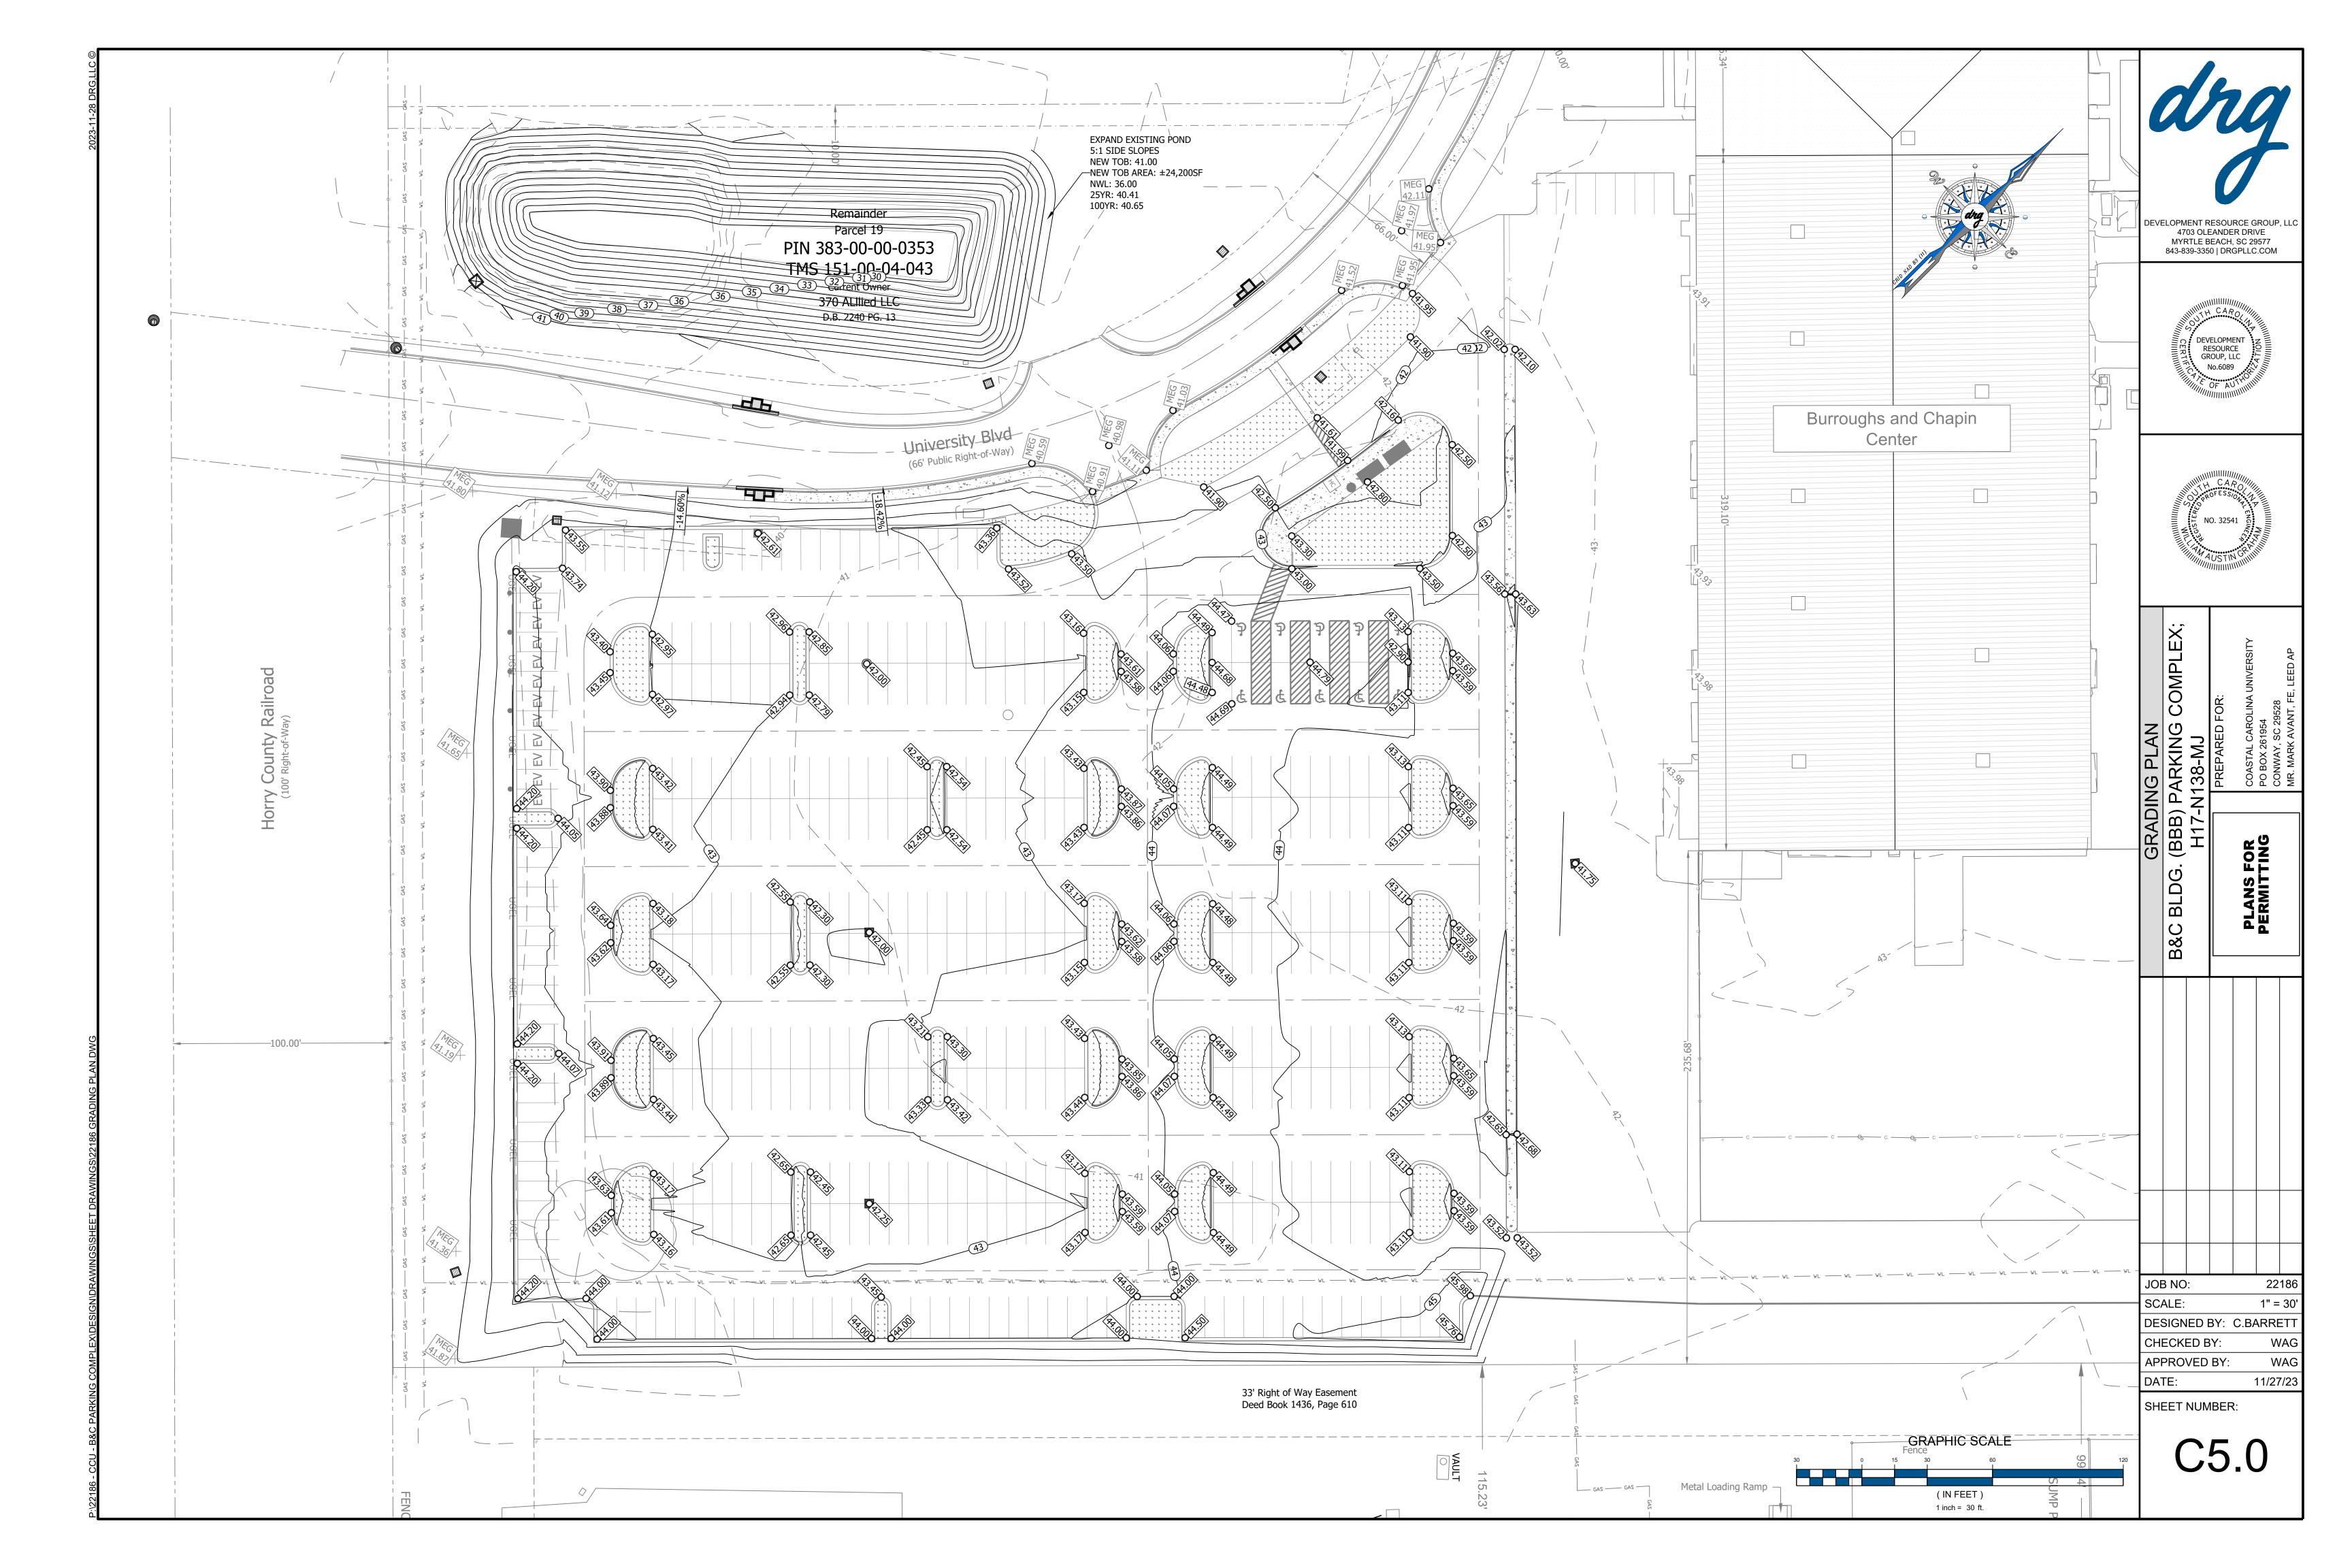
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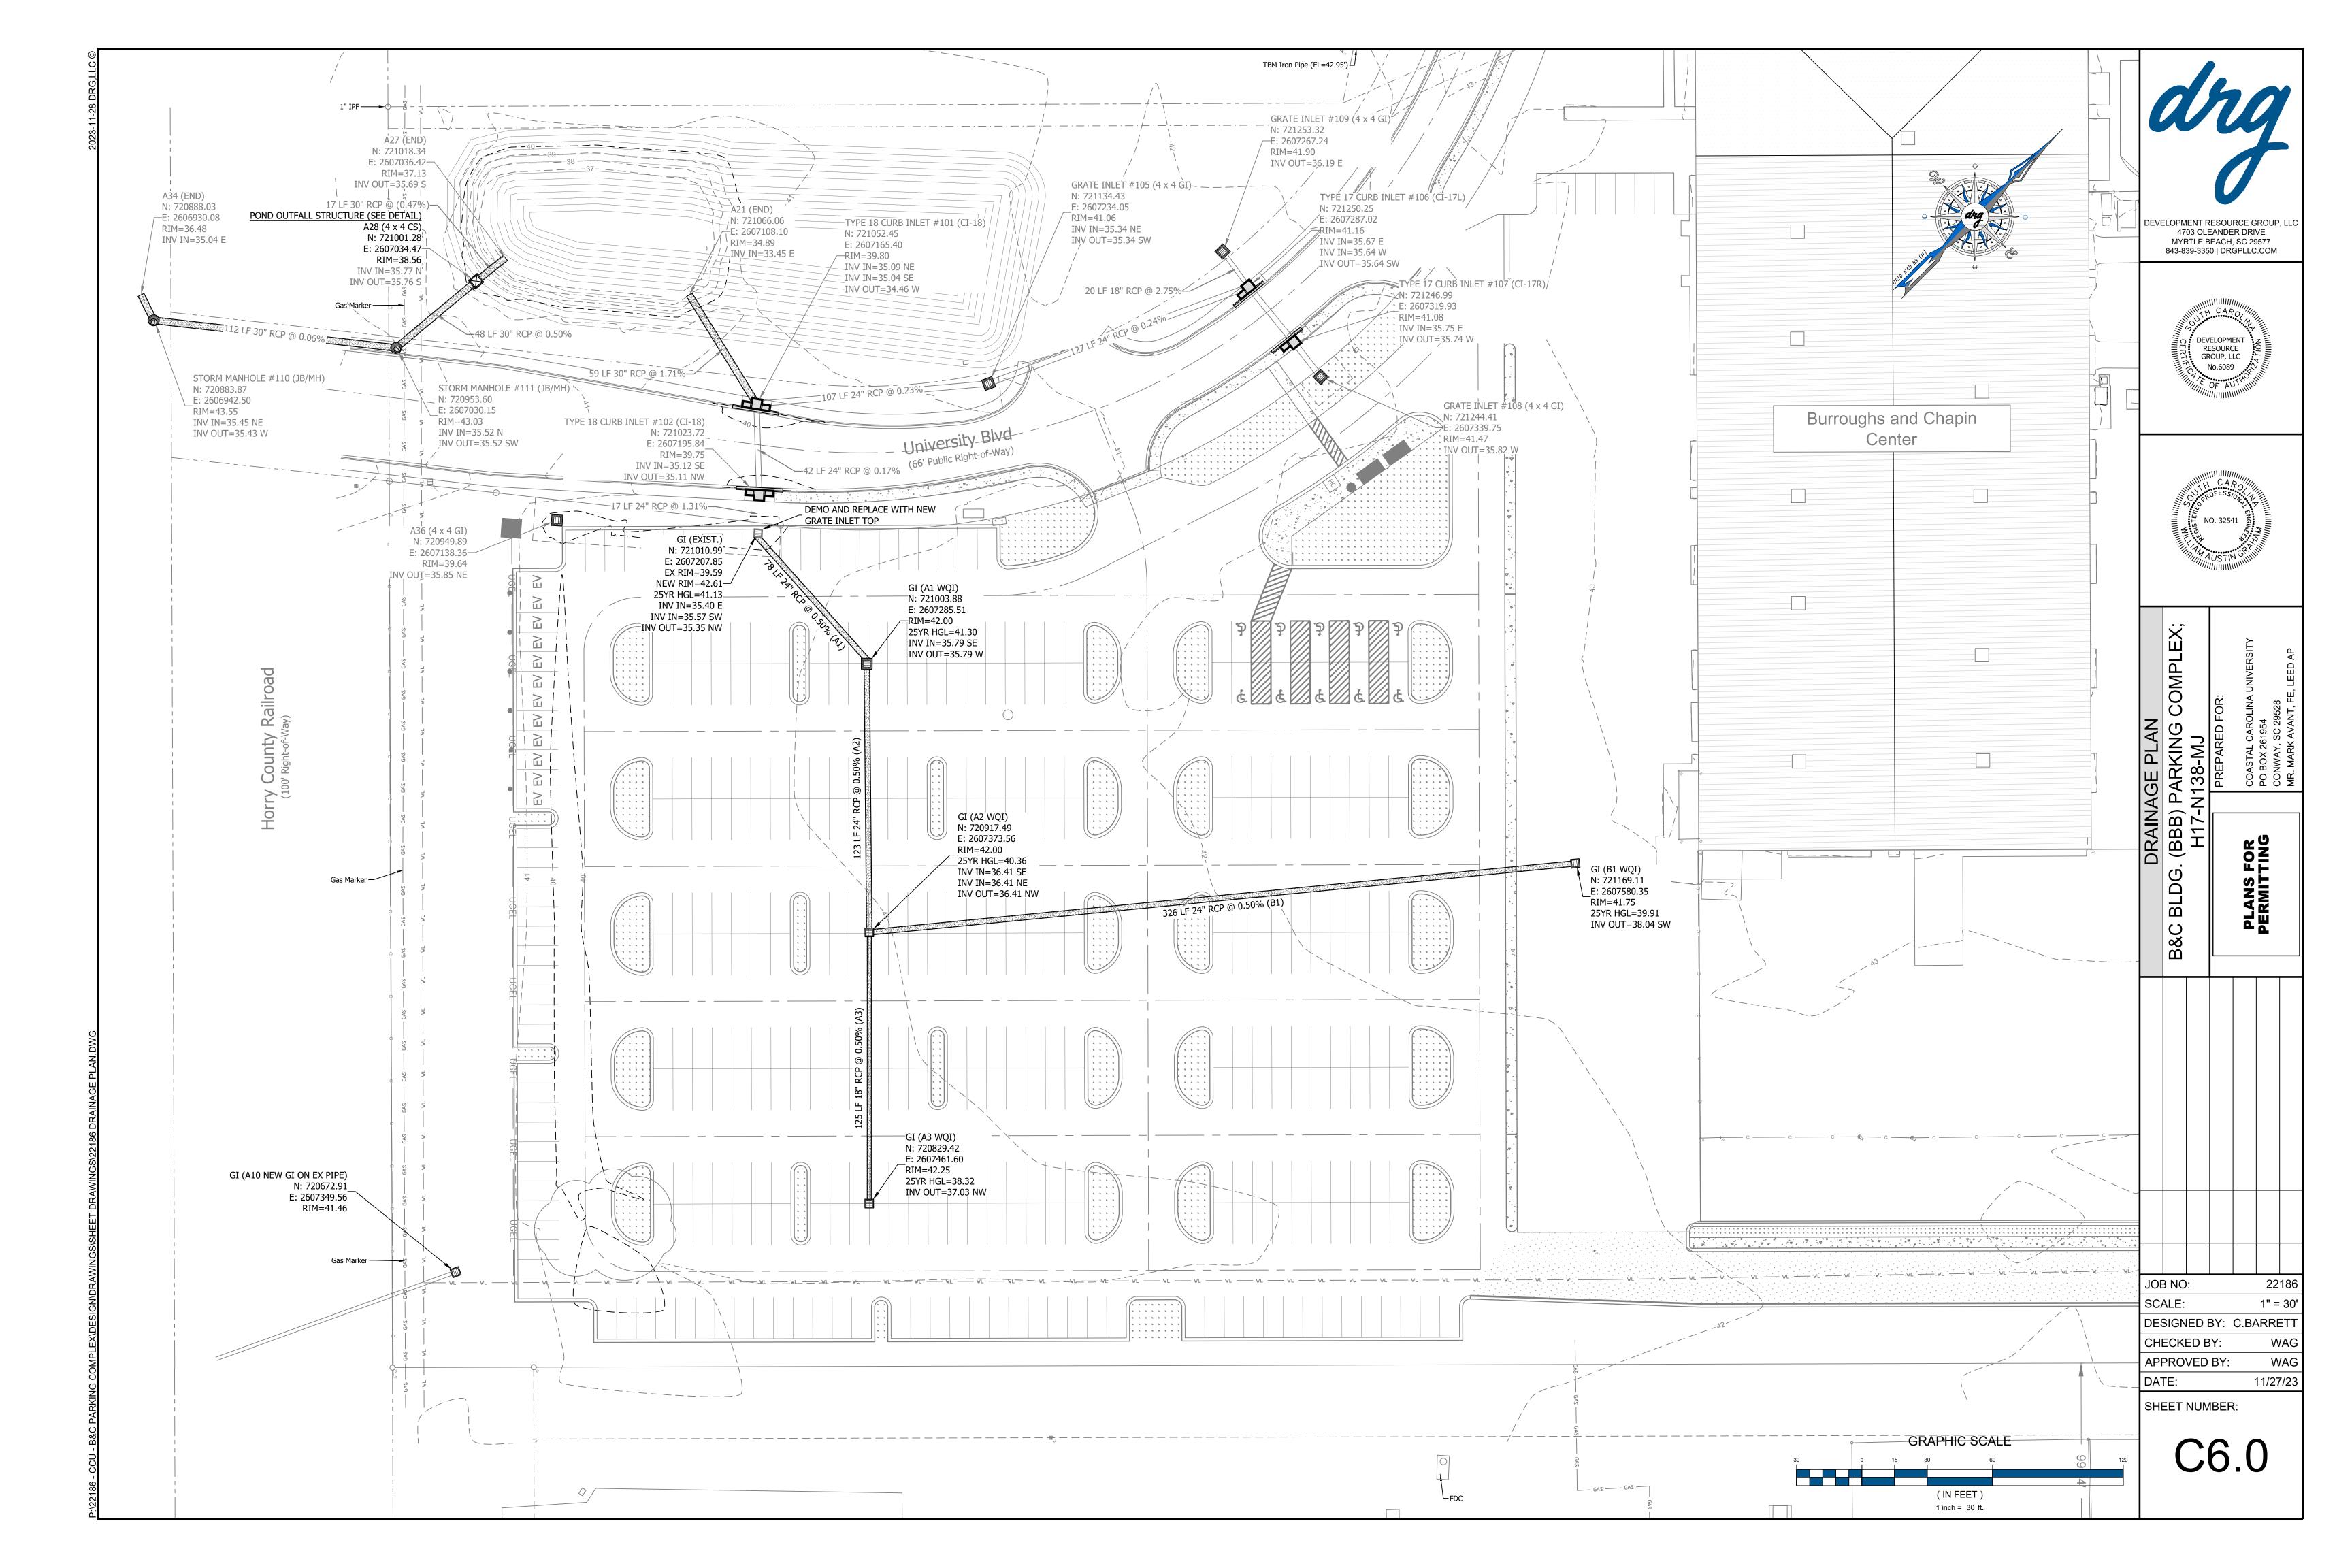
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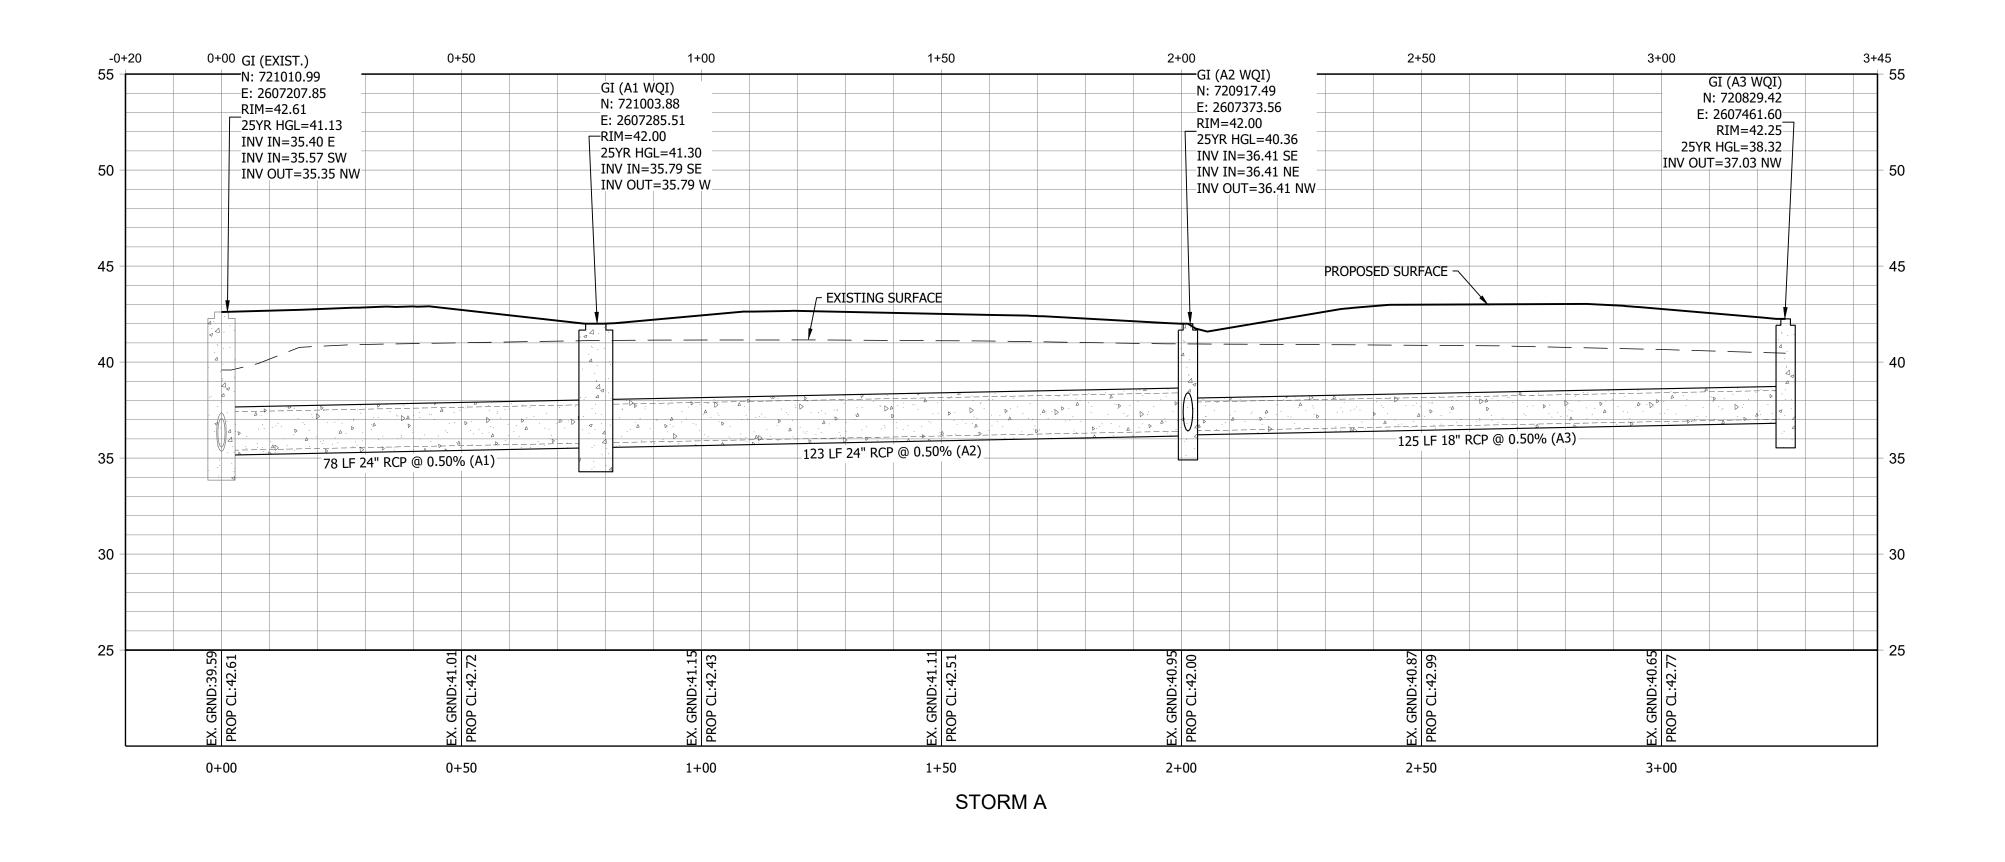
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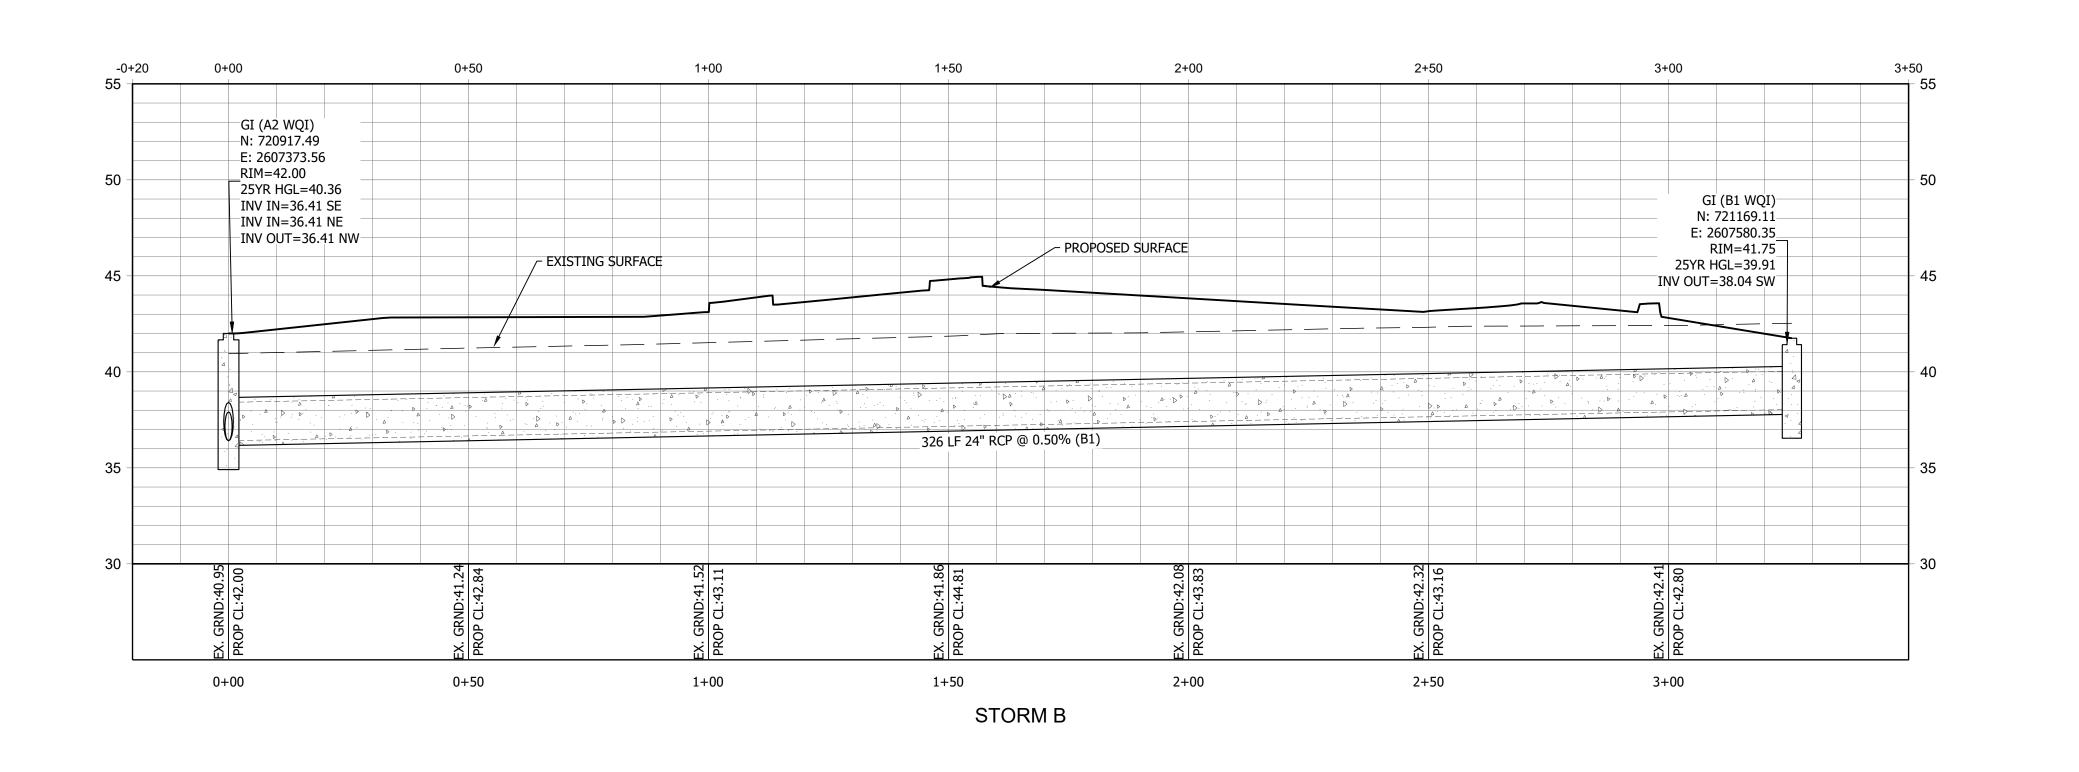











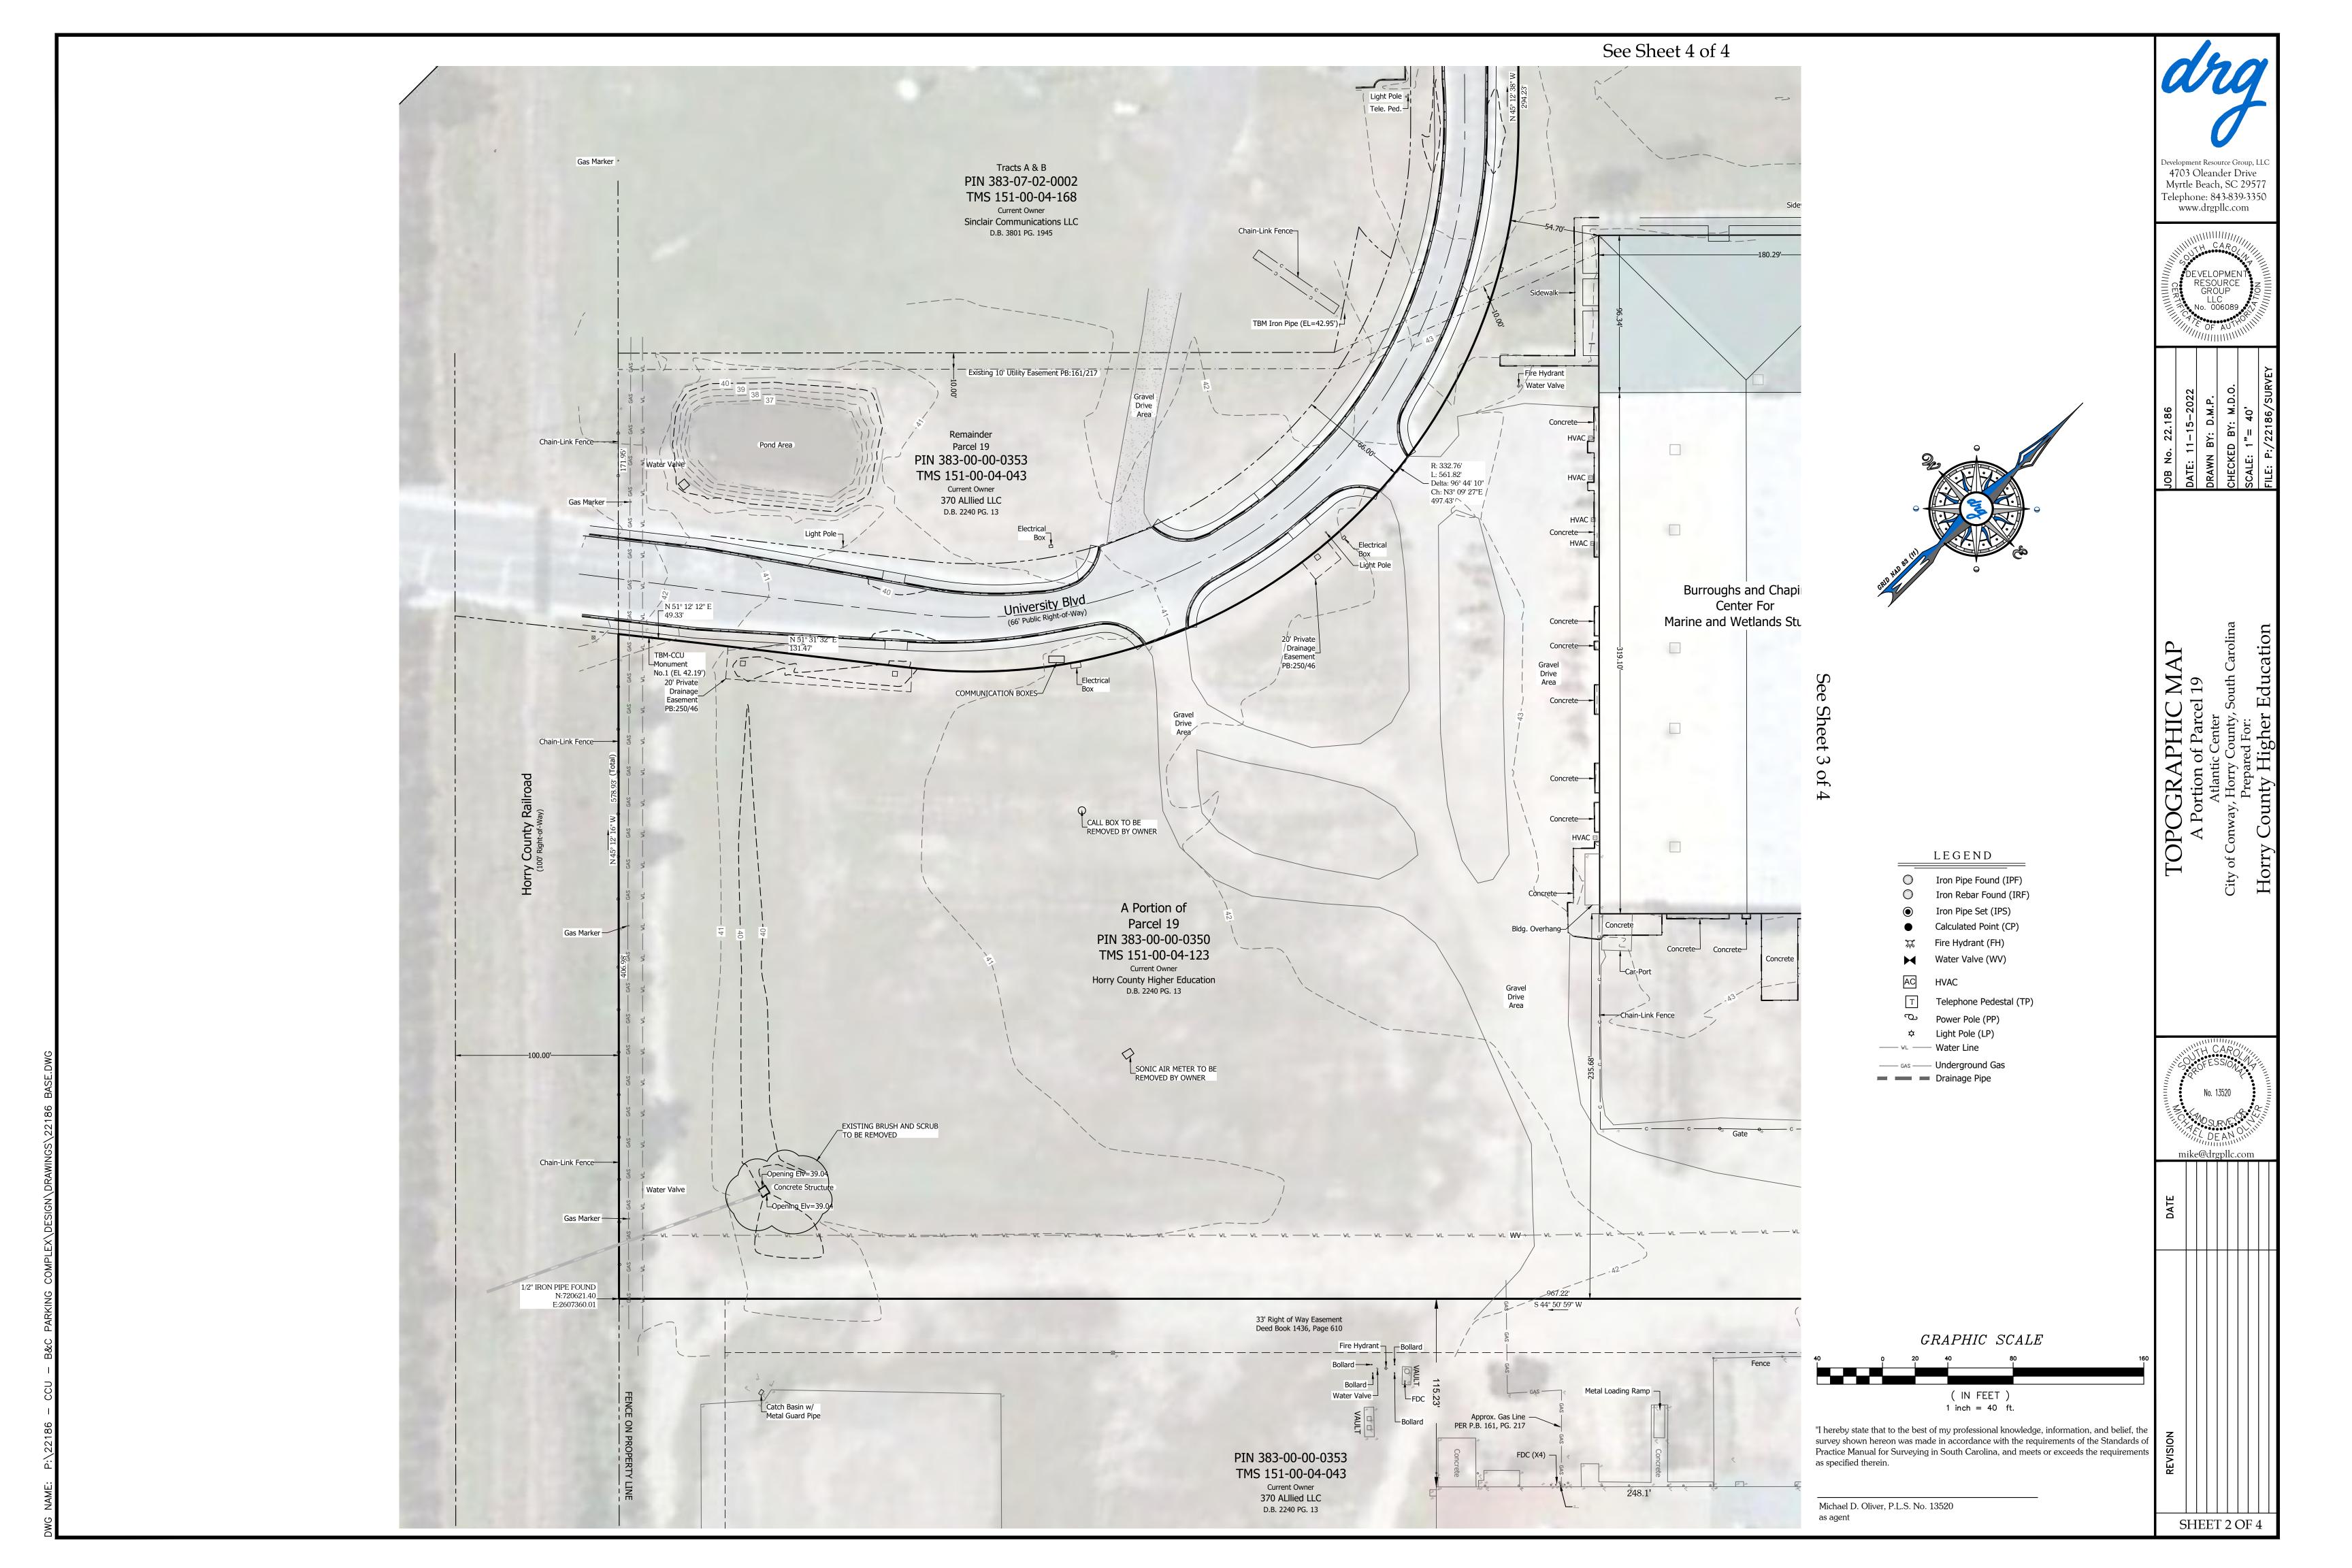

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N138-MJ
PREPARED FOR:
COASTAL CAROLINA UNIVERSITY
PO BOX 261954

LANS FOR ERMITTING

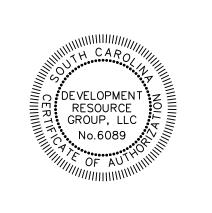JOB NO: 22186

JOB NO: 22186

SCALE: 1" = 20'

DESIGNED BY: C.BARRETT

CHECKED BY: WAG


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APPROVED BY: WAG
DATE: 11/27/23


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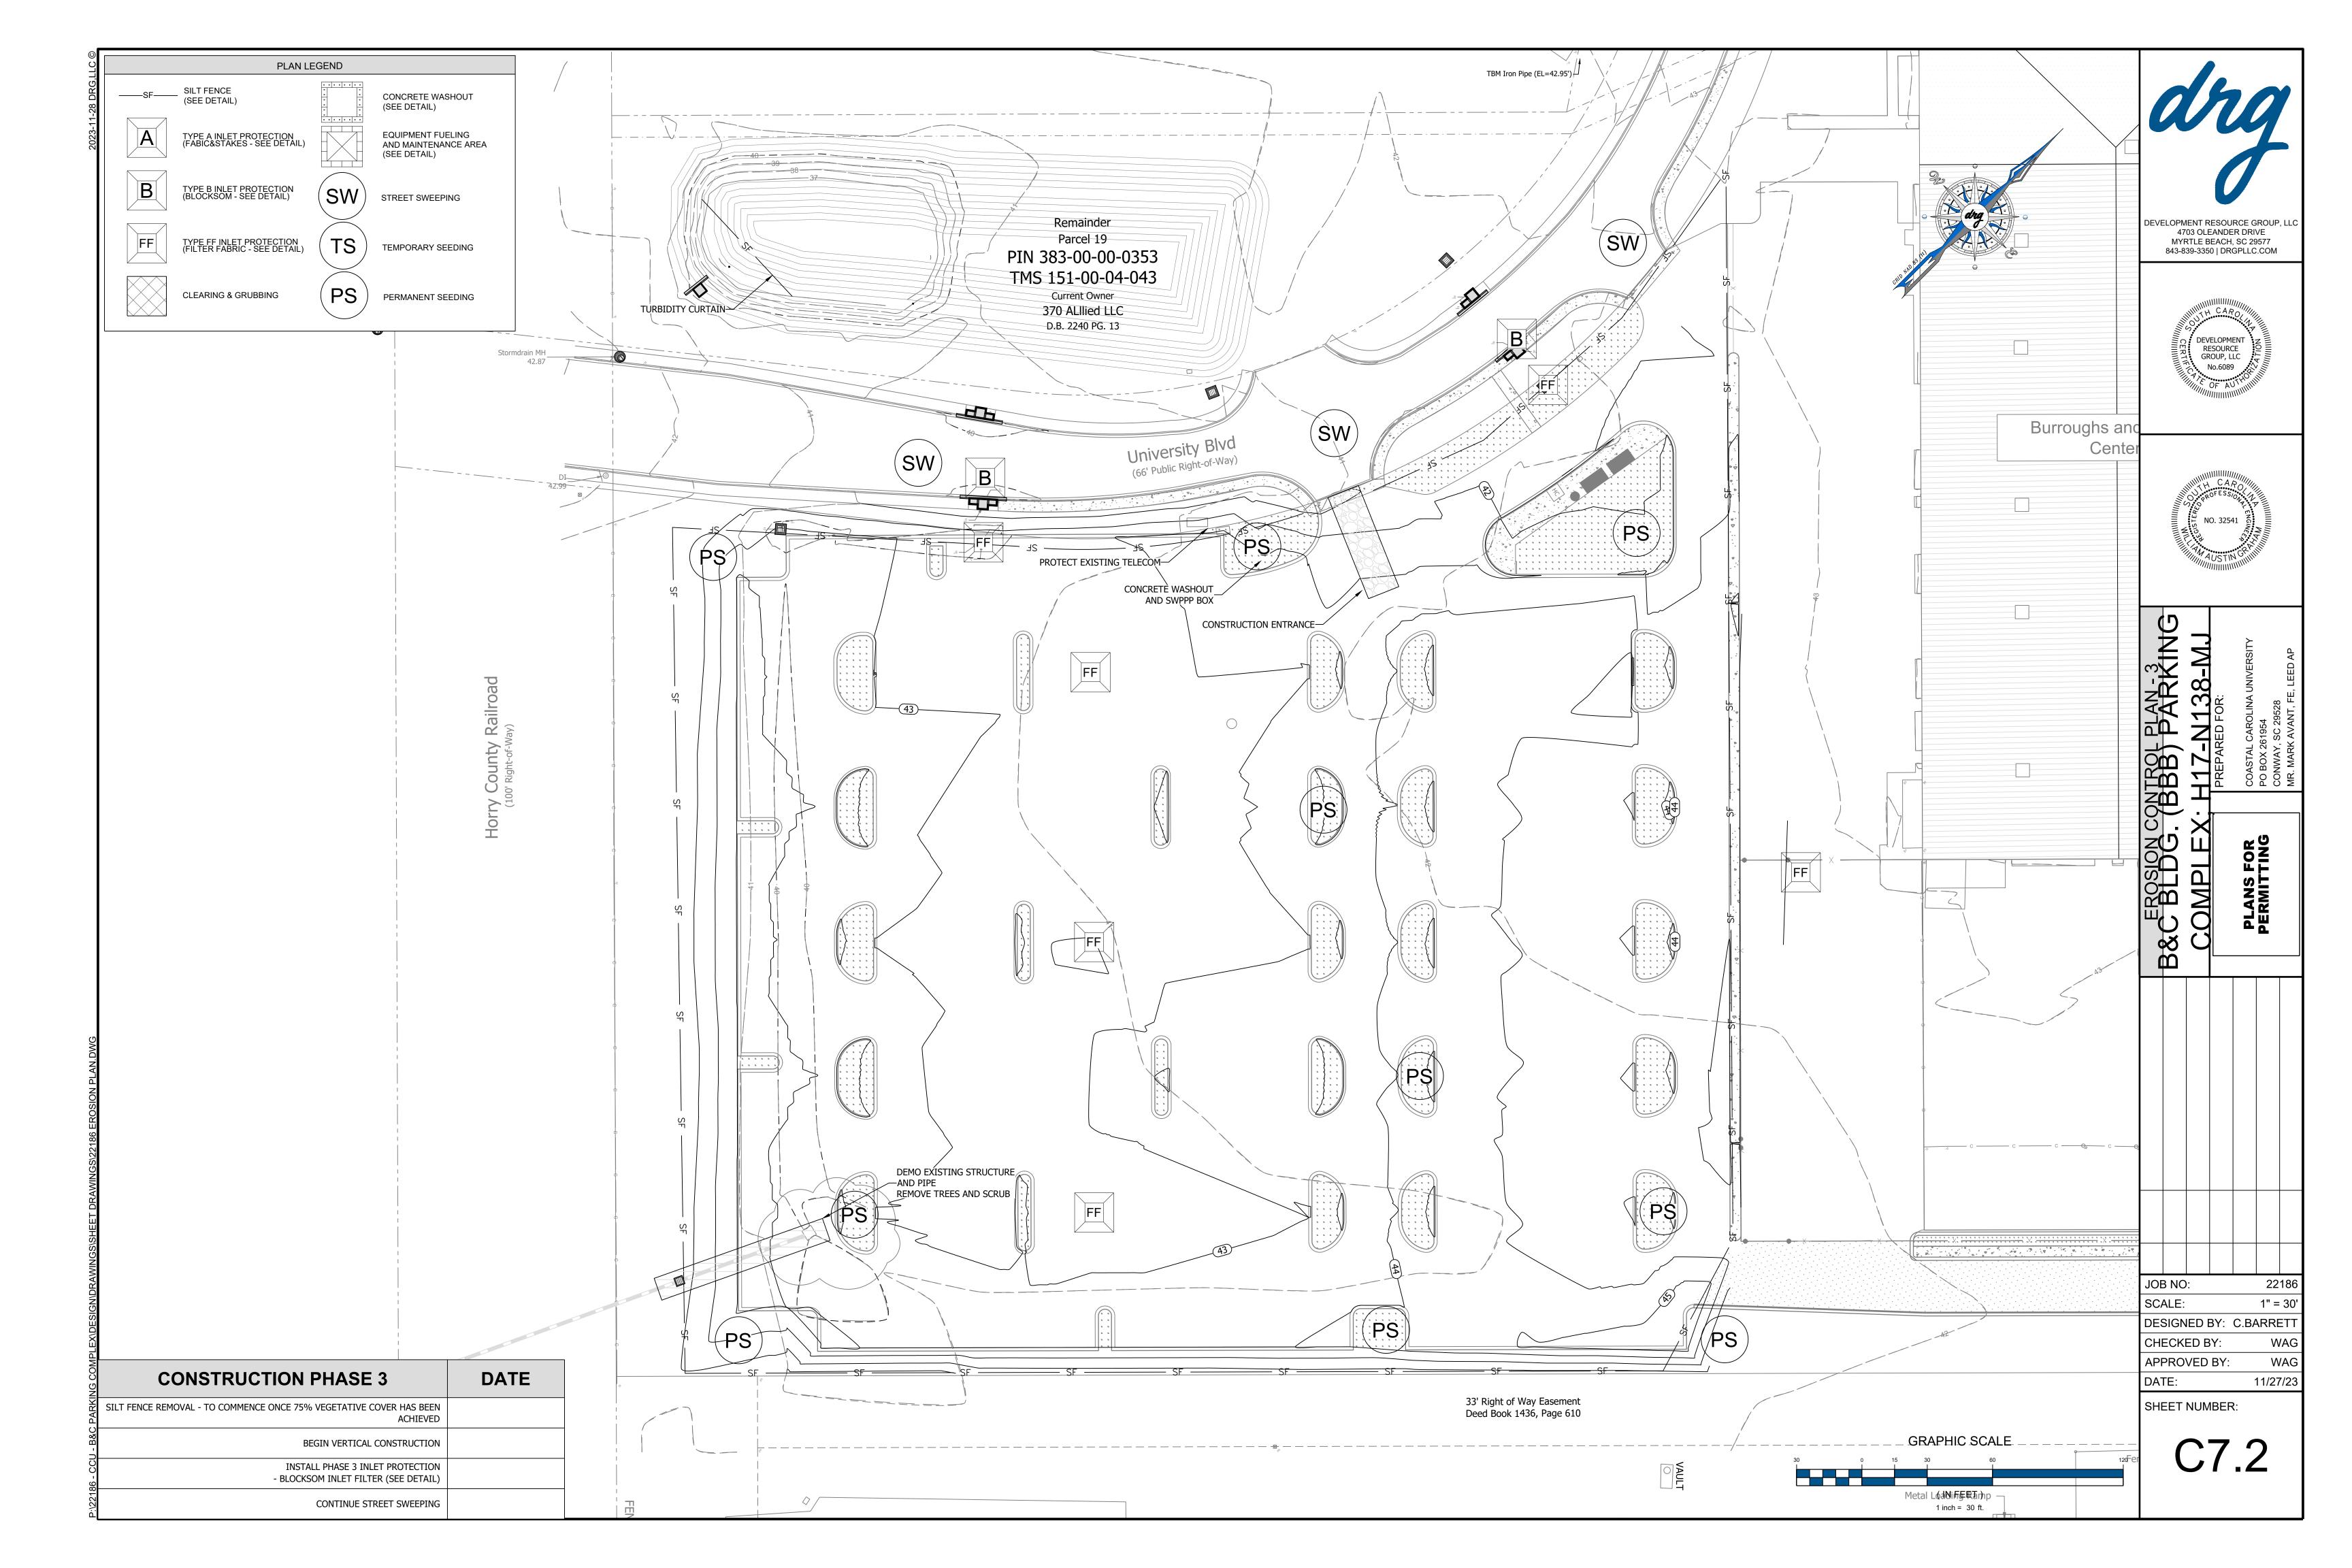
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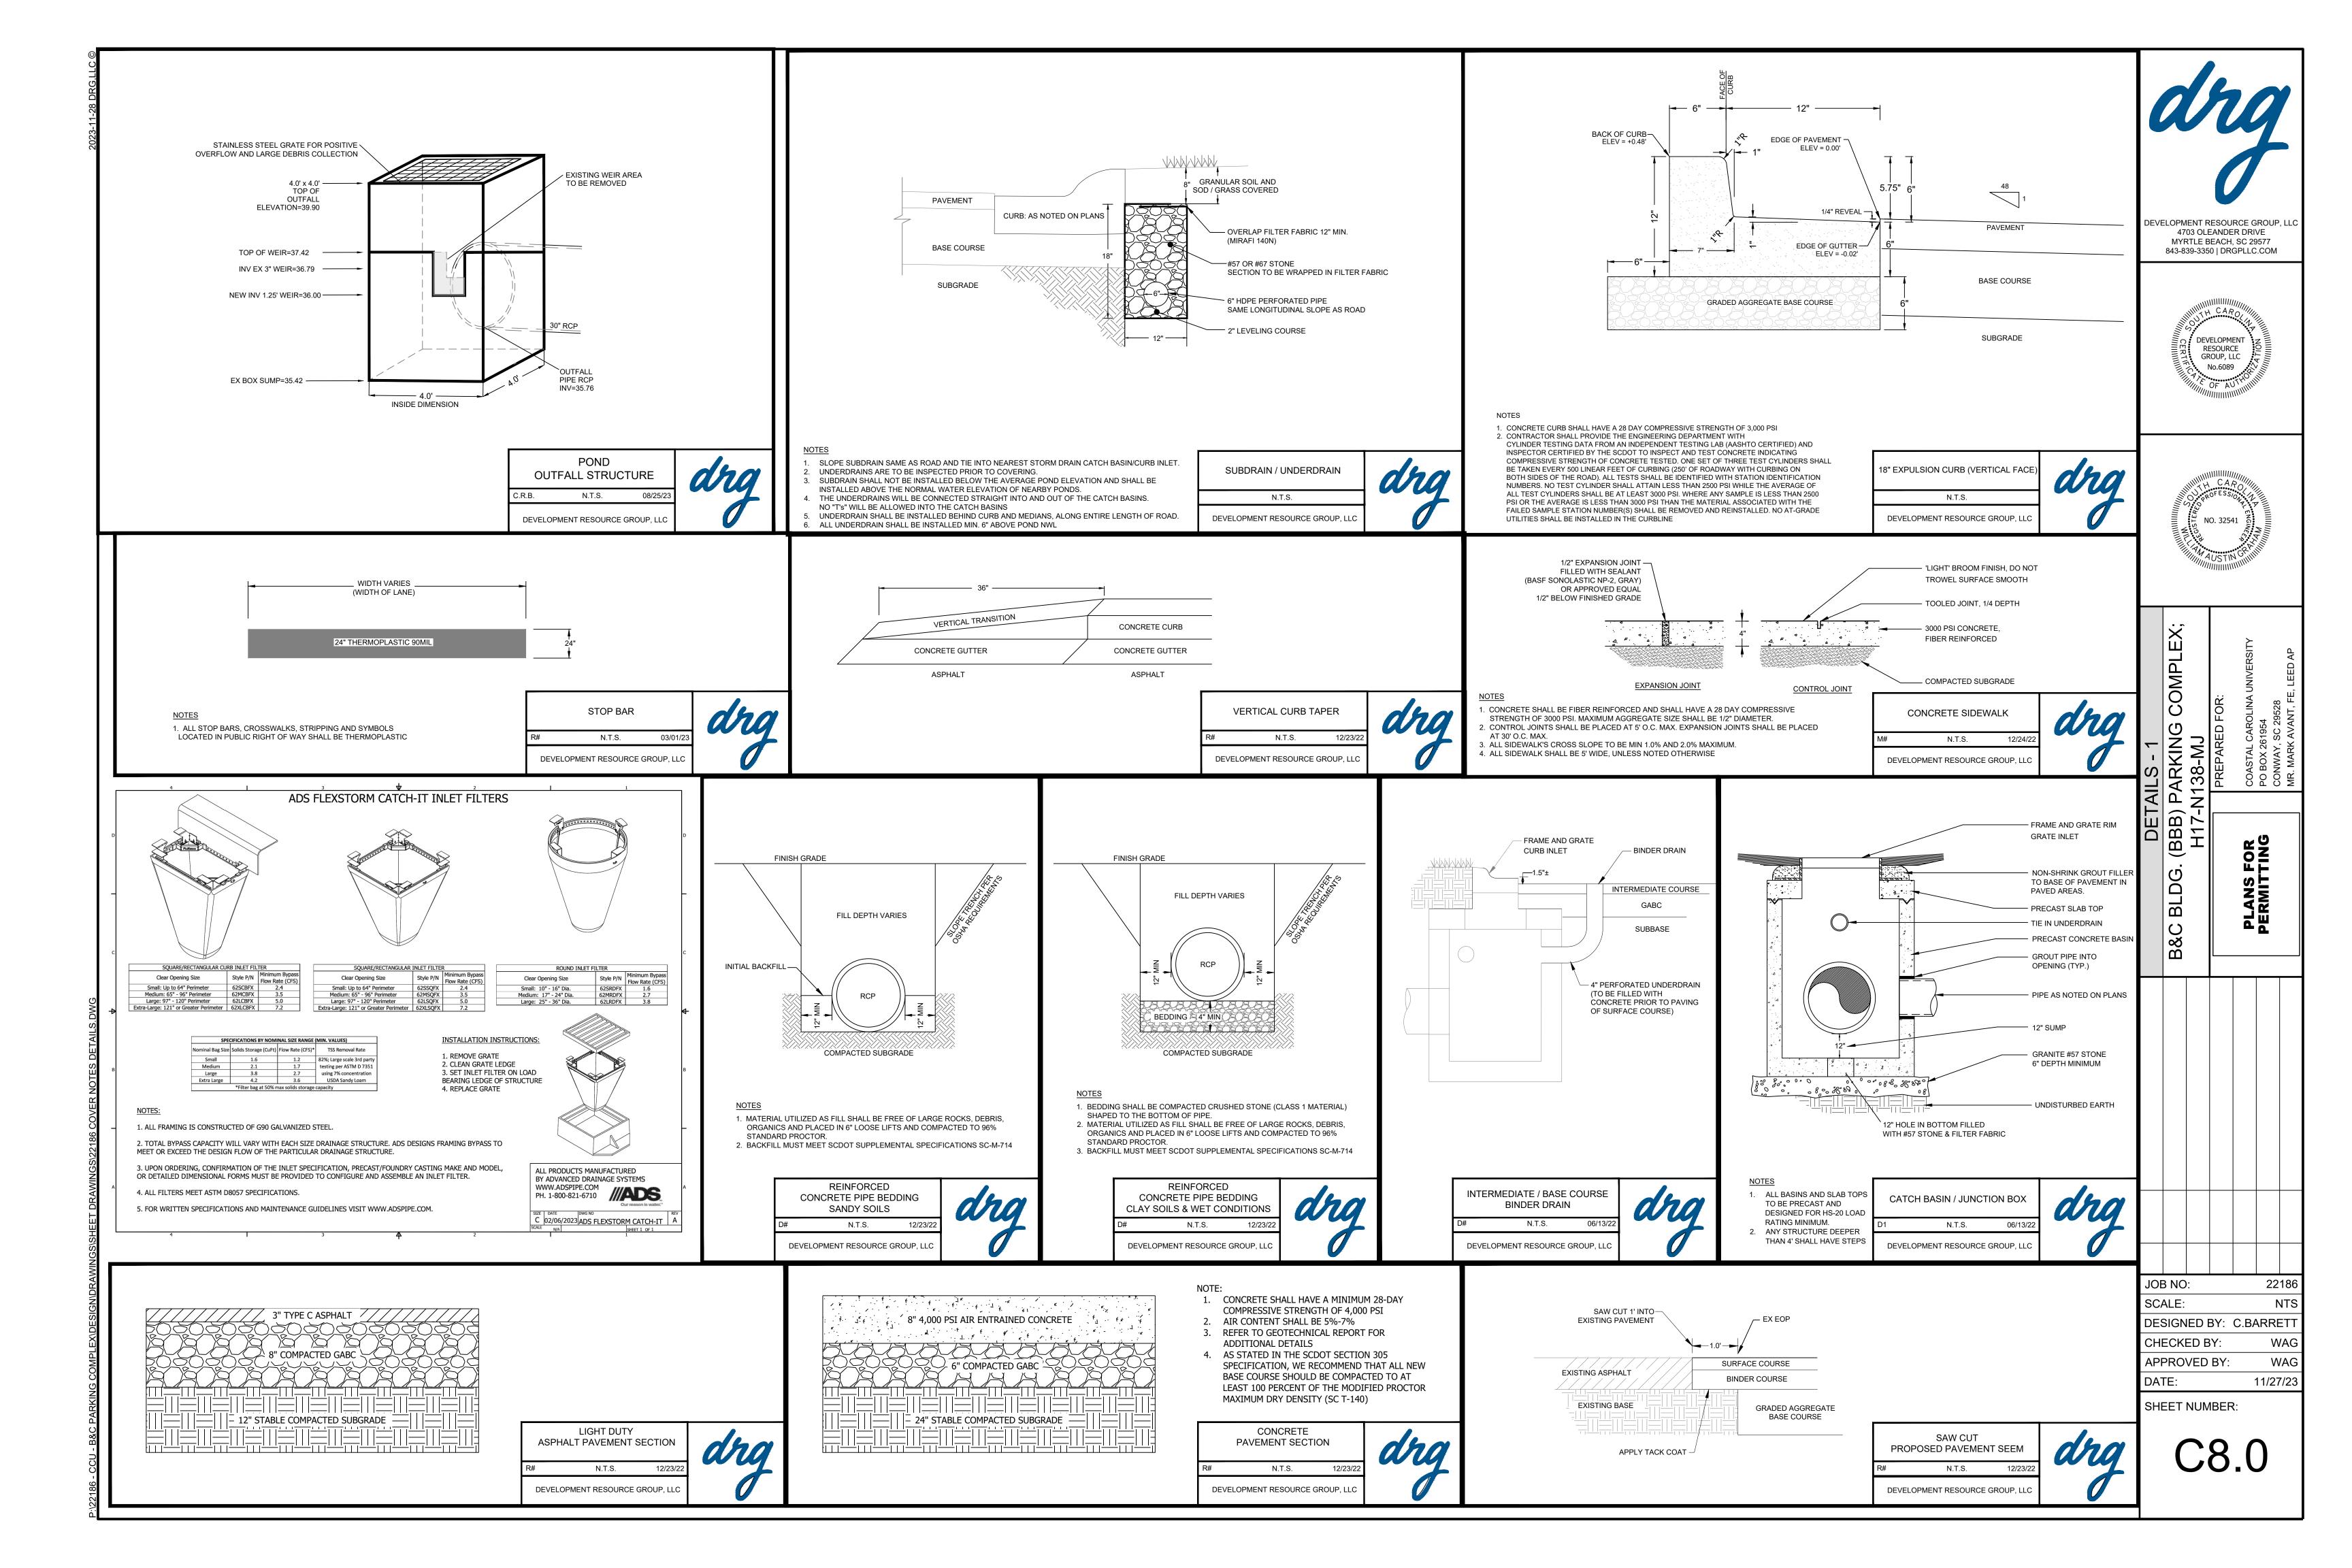
GRAPHIC SCALE


( IN FEET ) 1 inch = 5/20 ft. C6.1






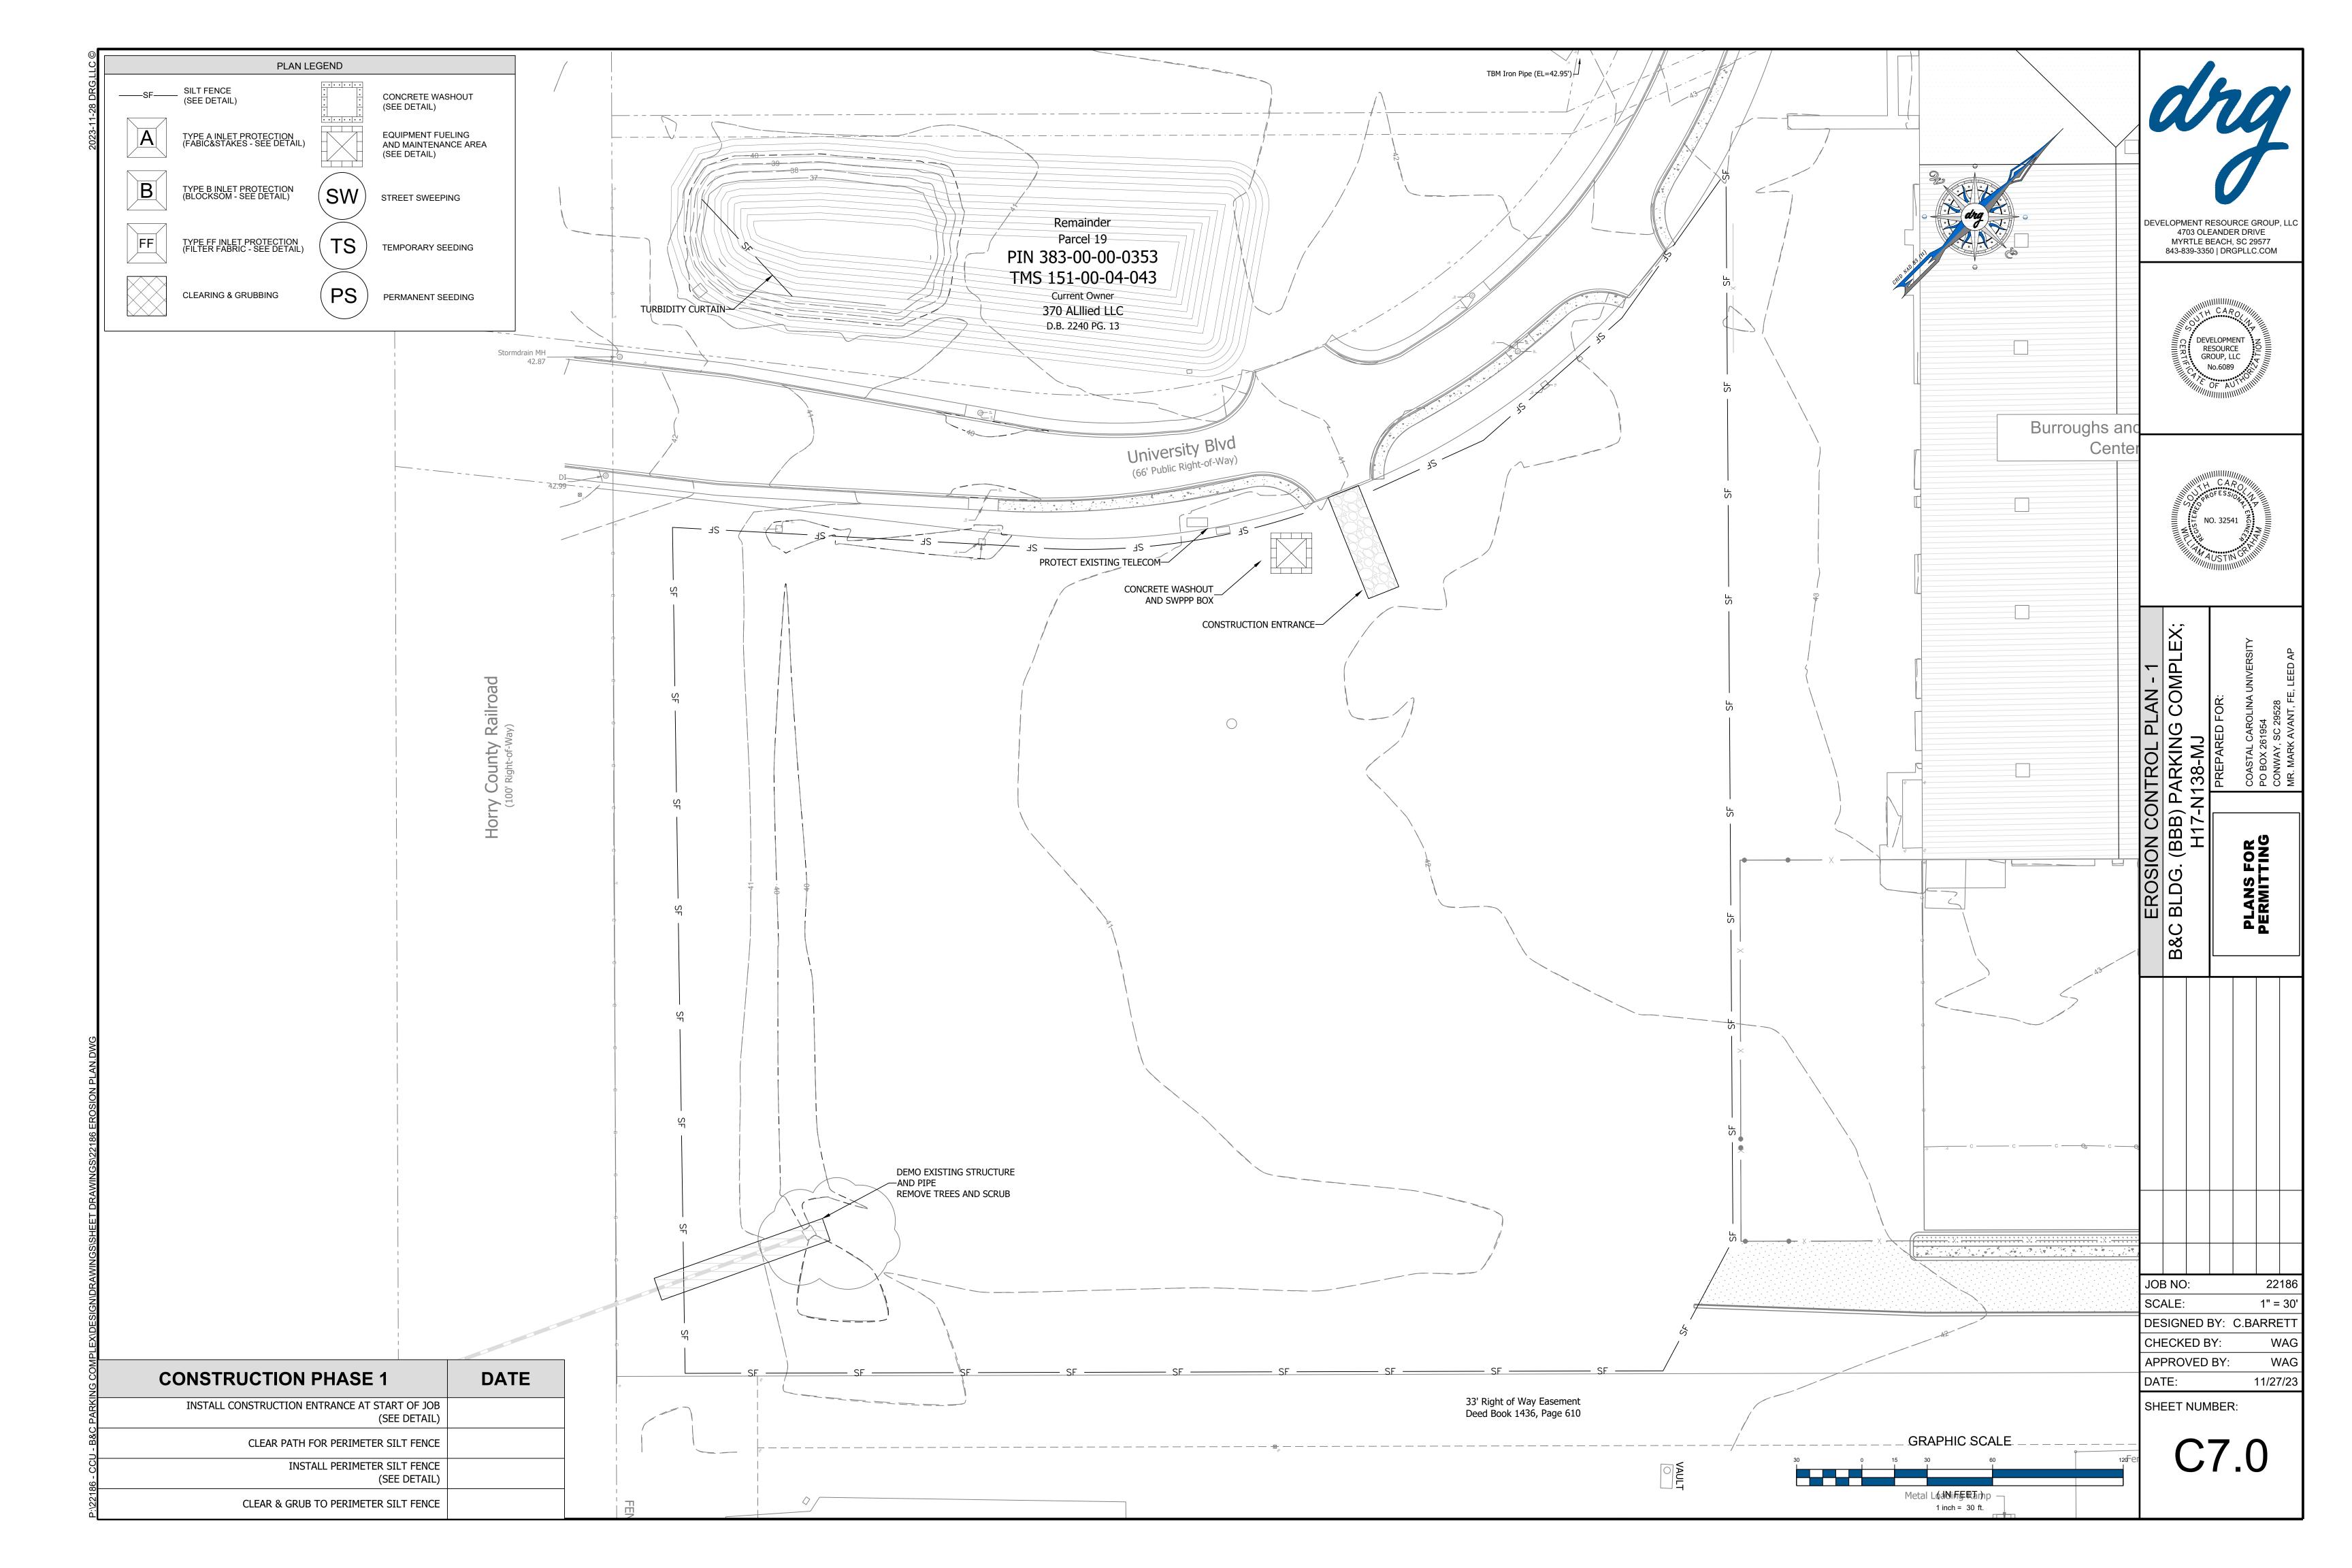

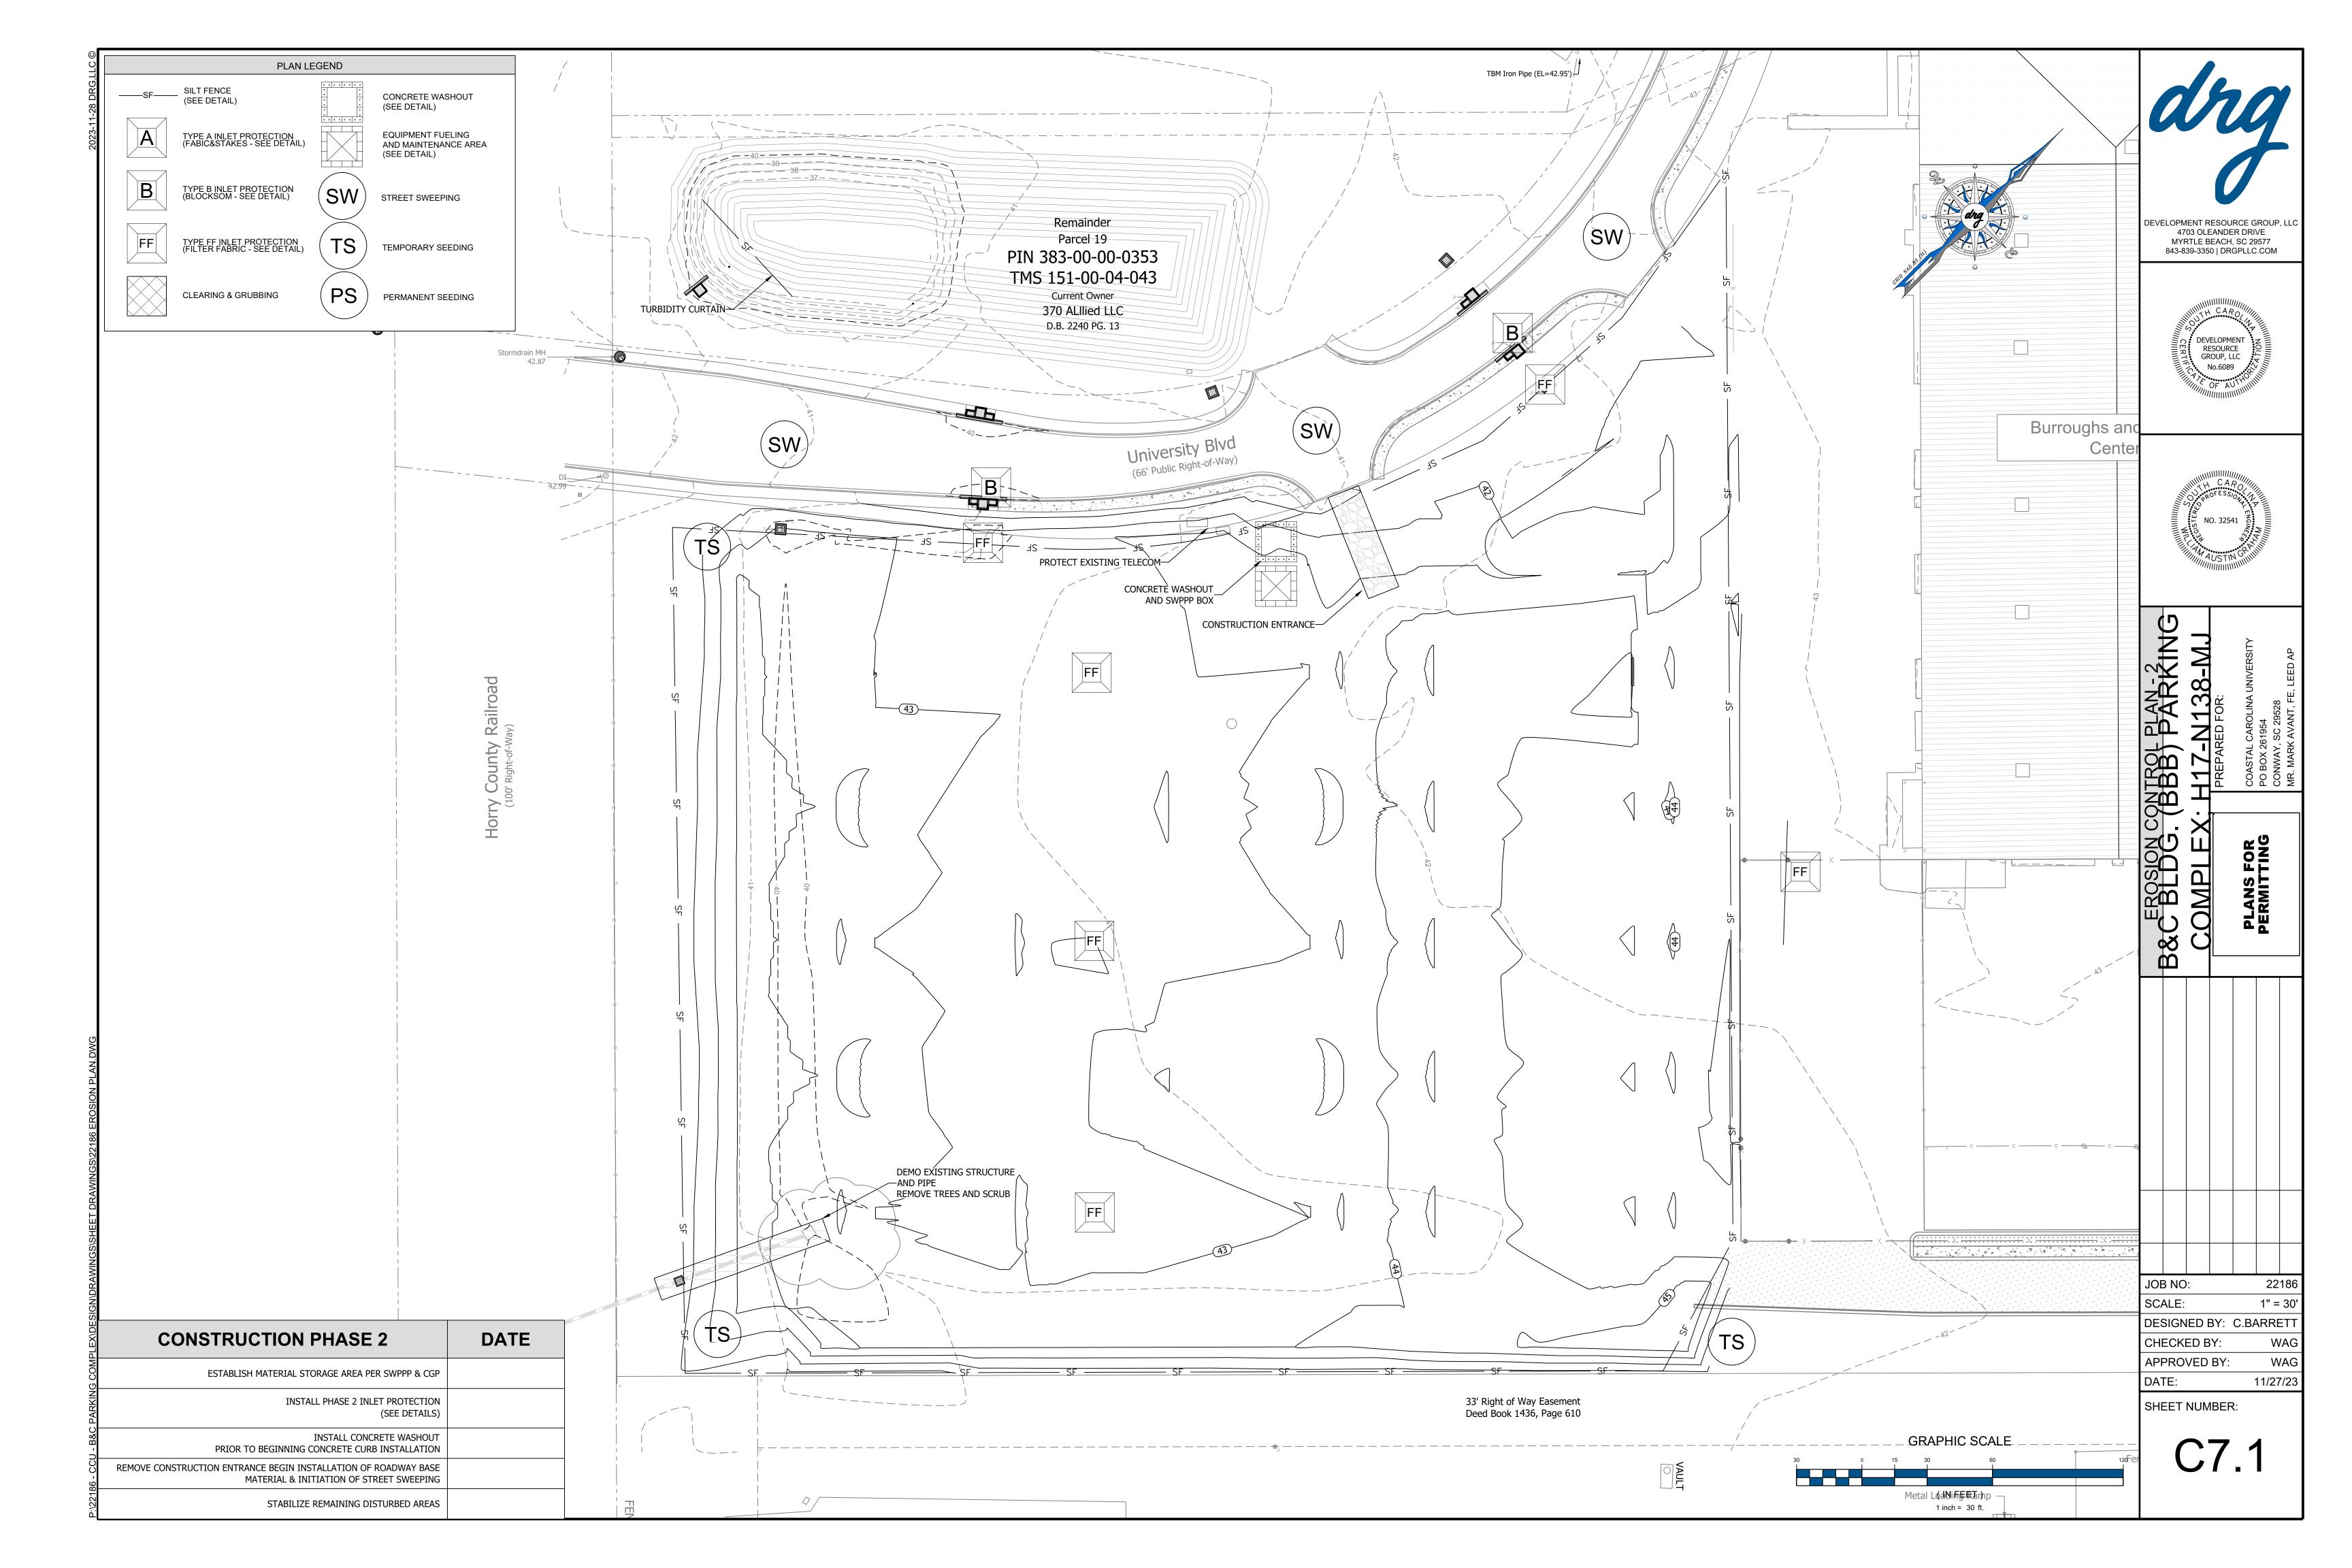

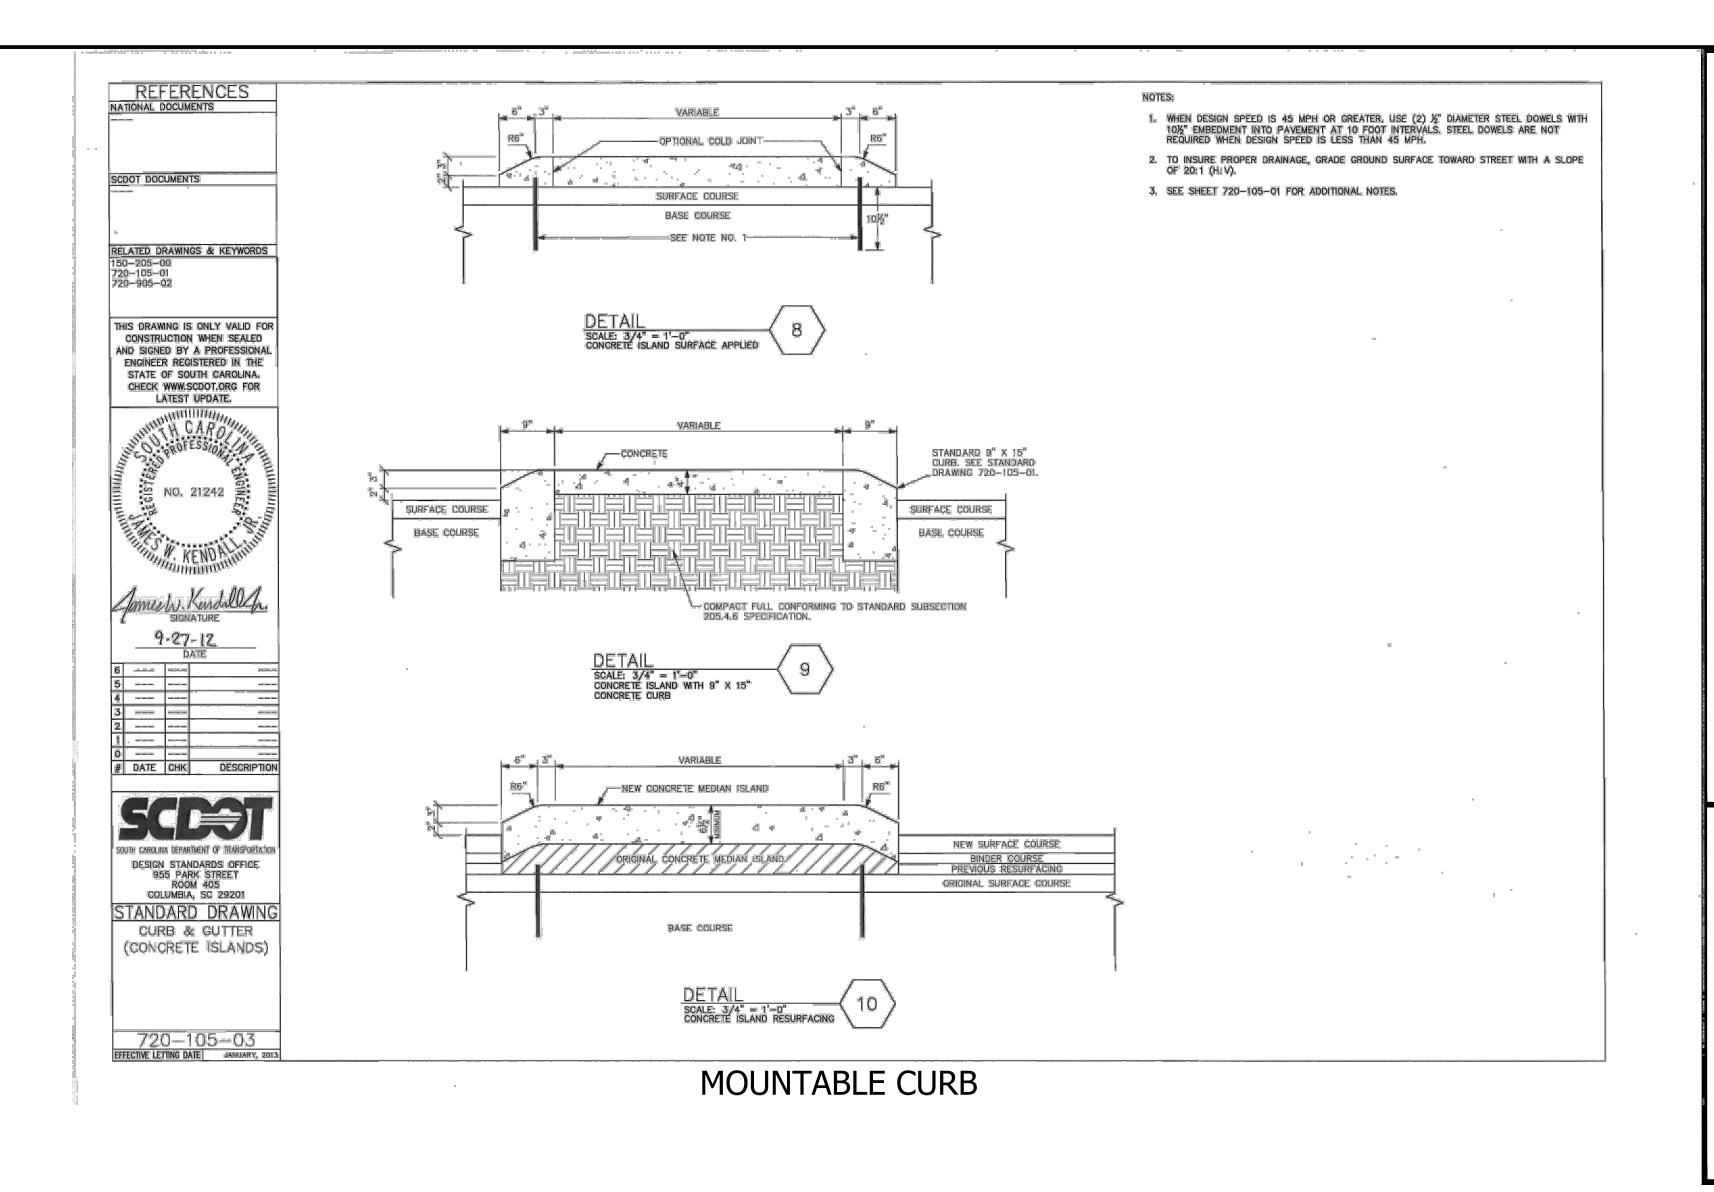

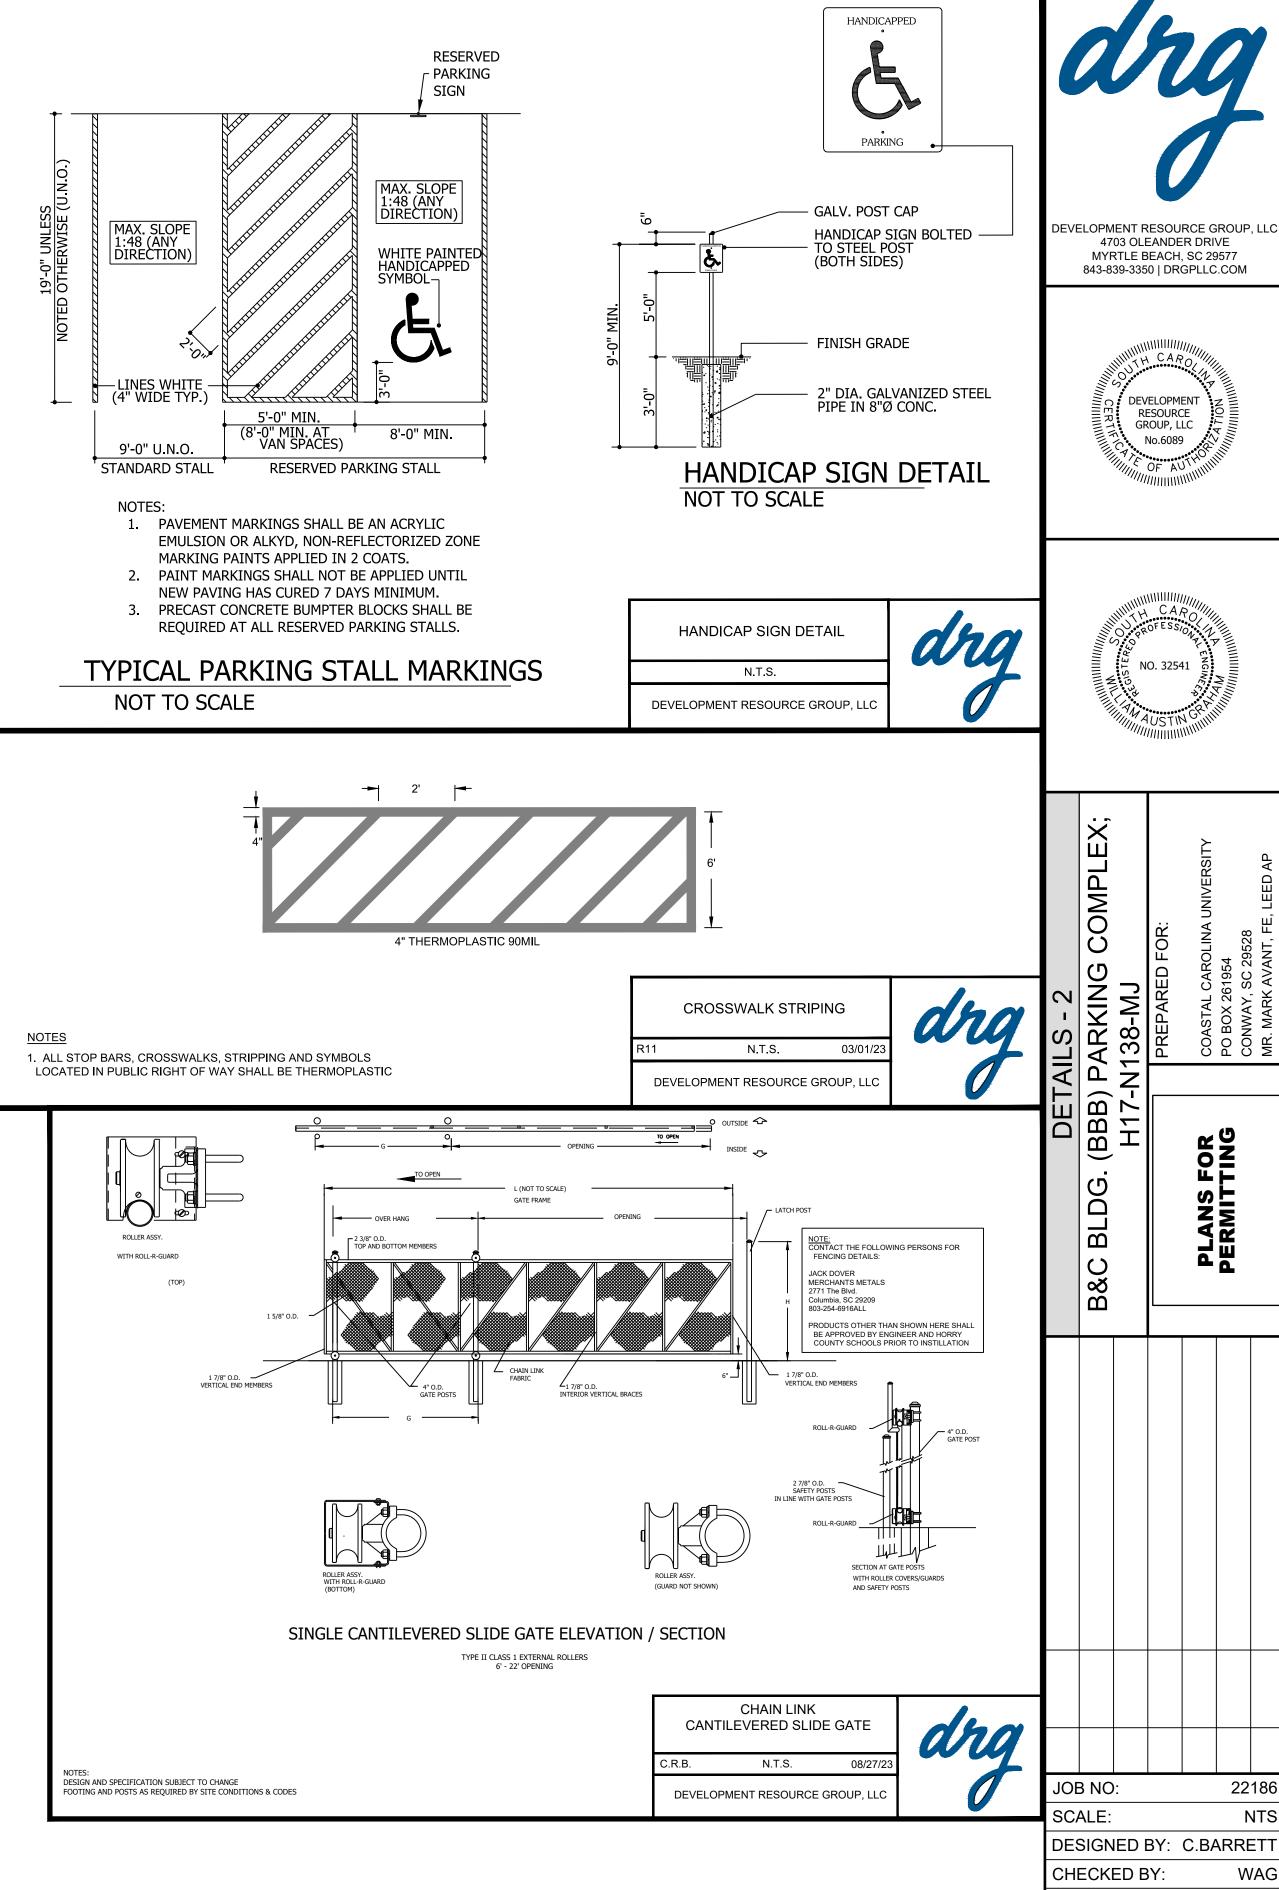


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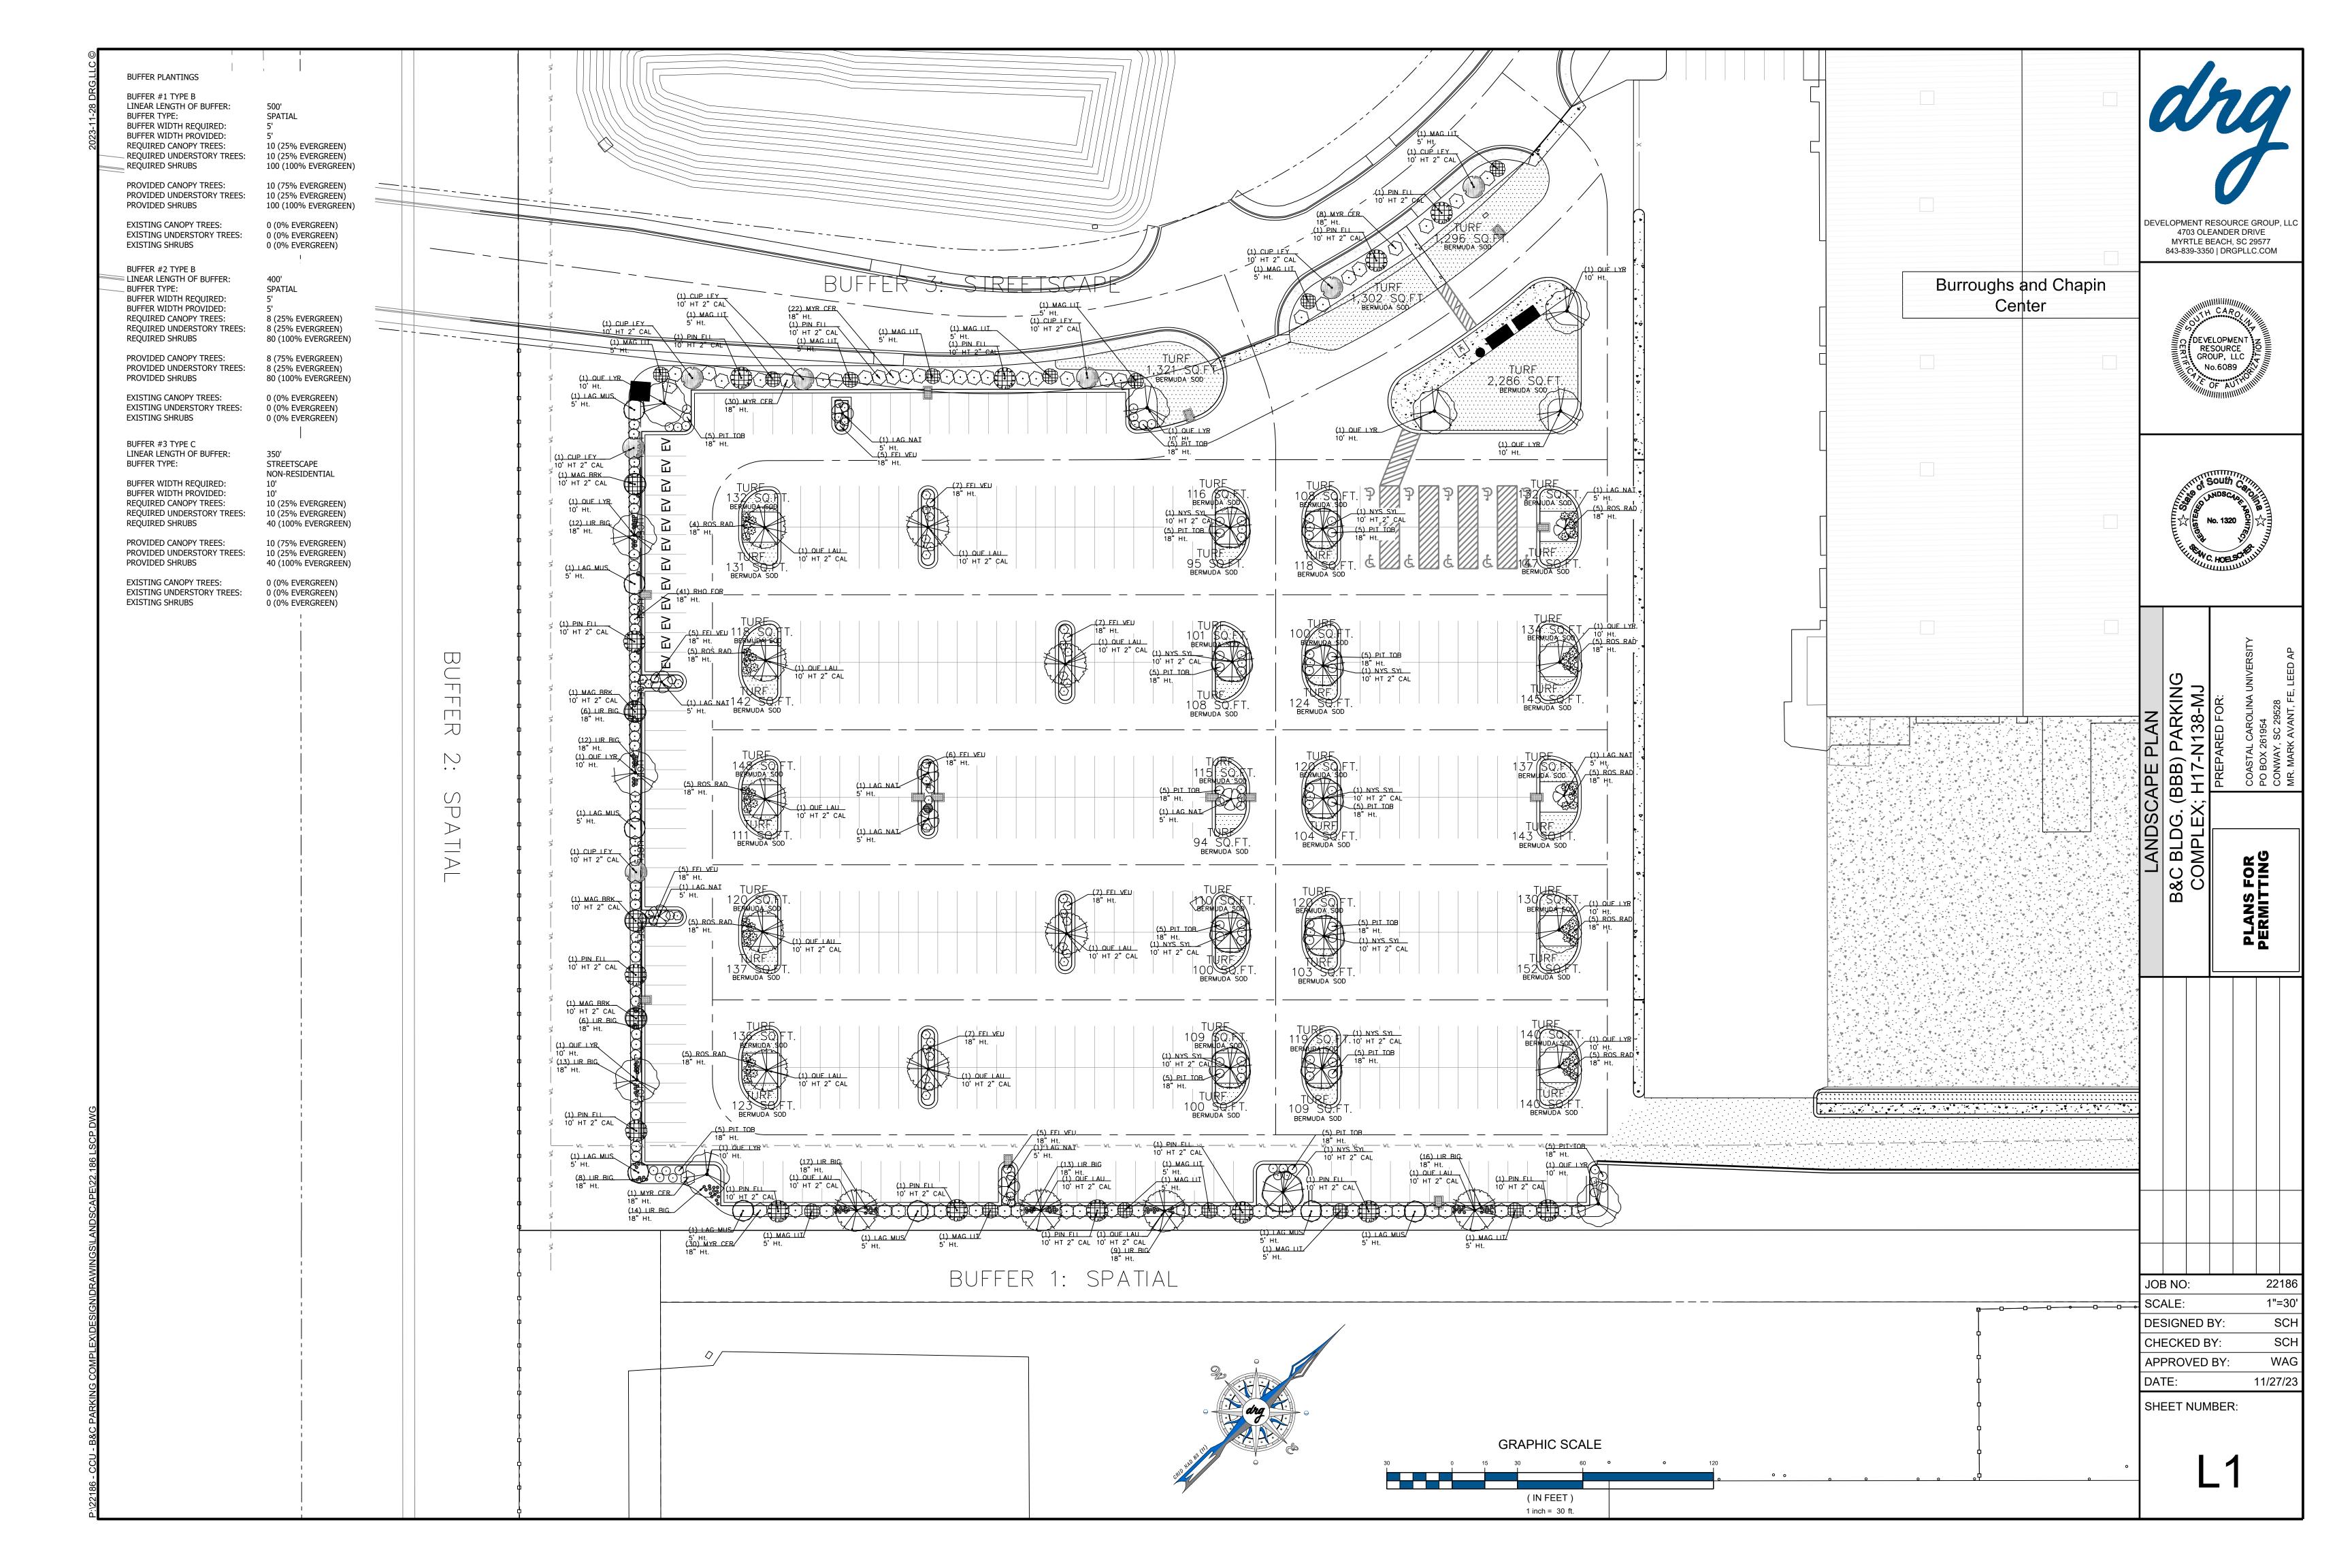
APPROVED BY:

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WAG

11/27/23



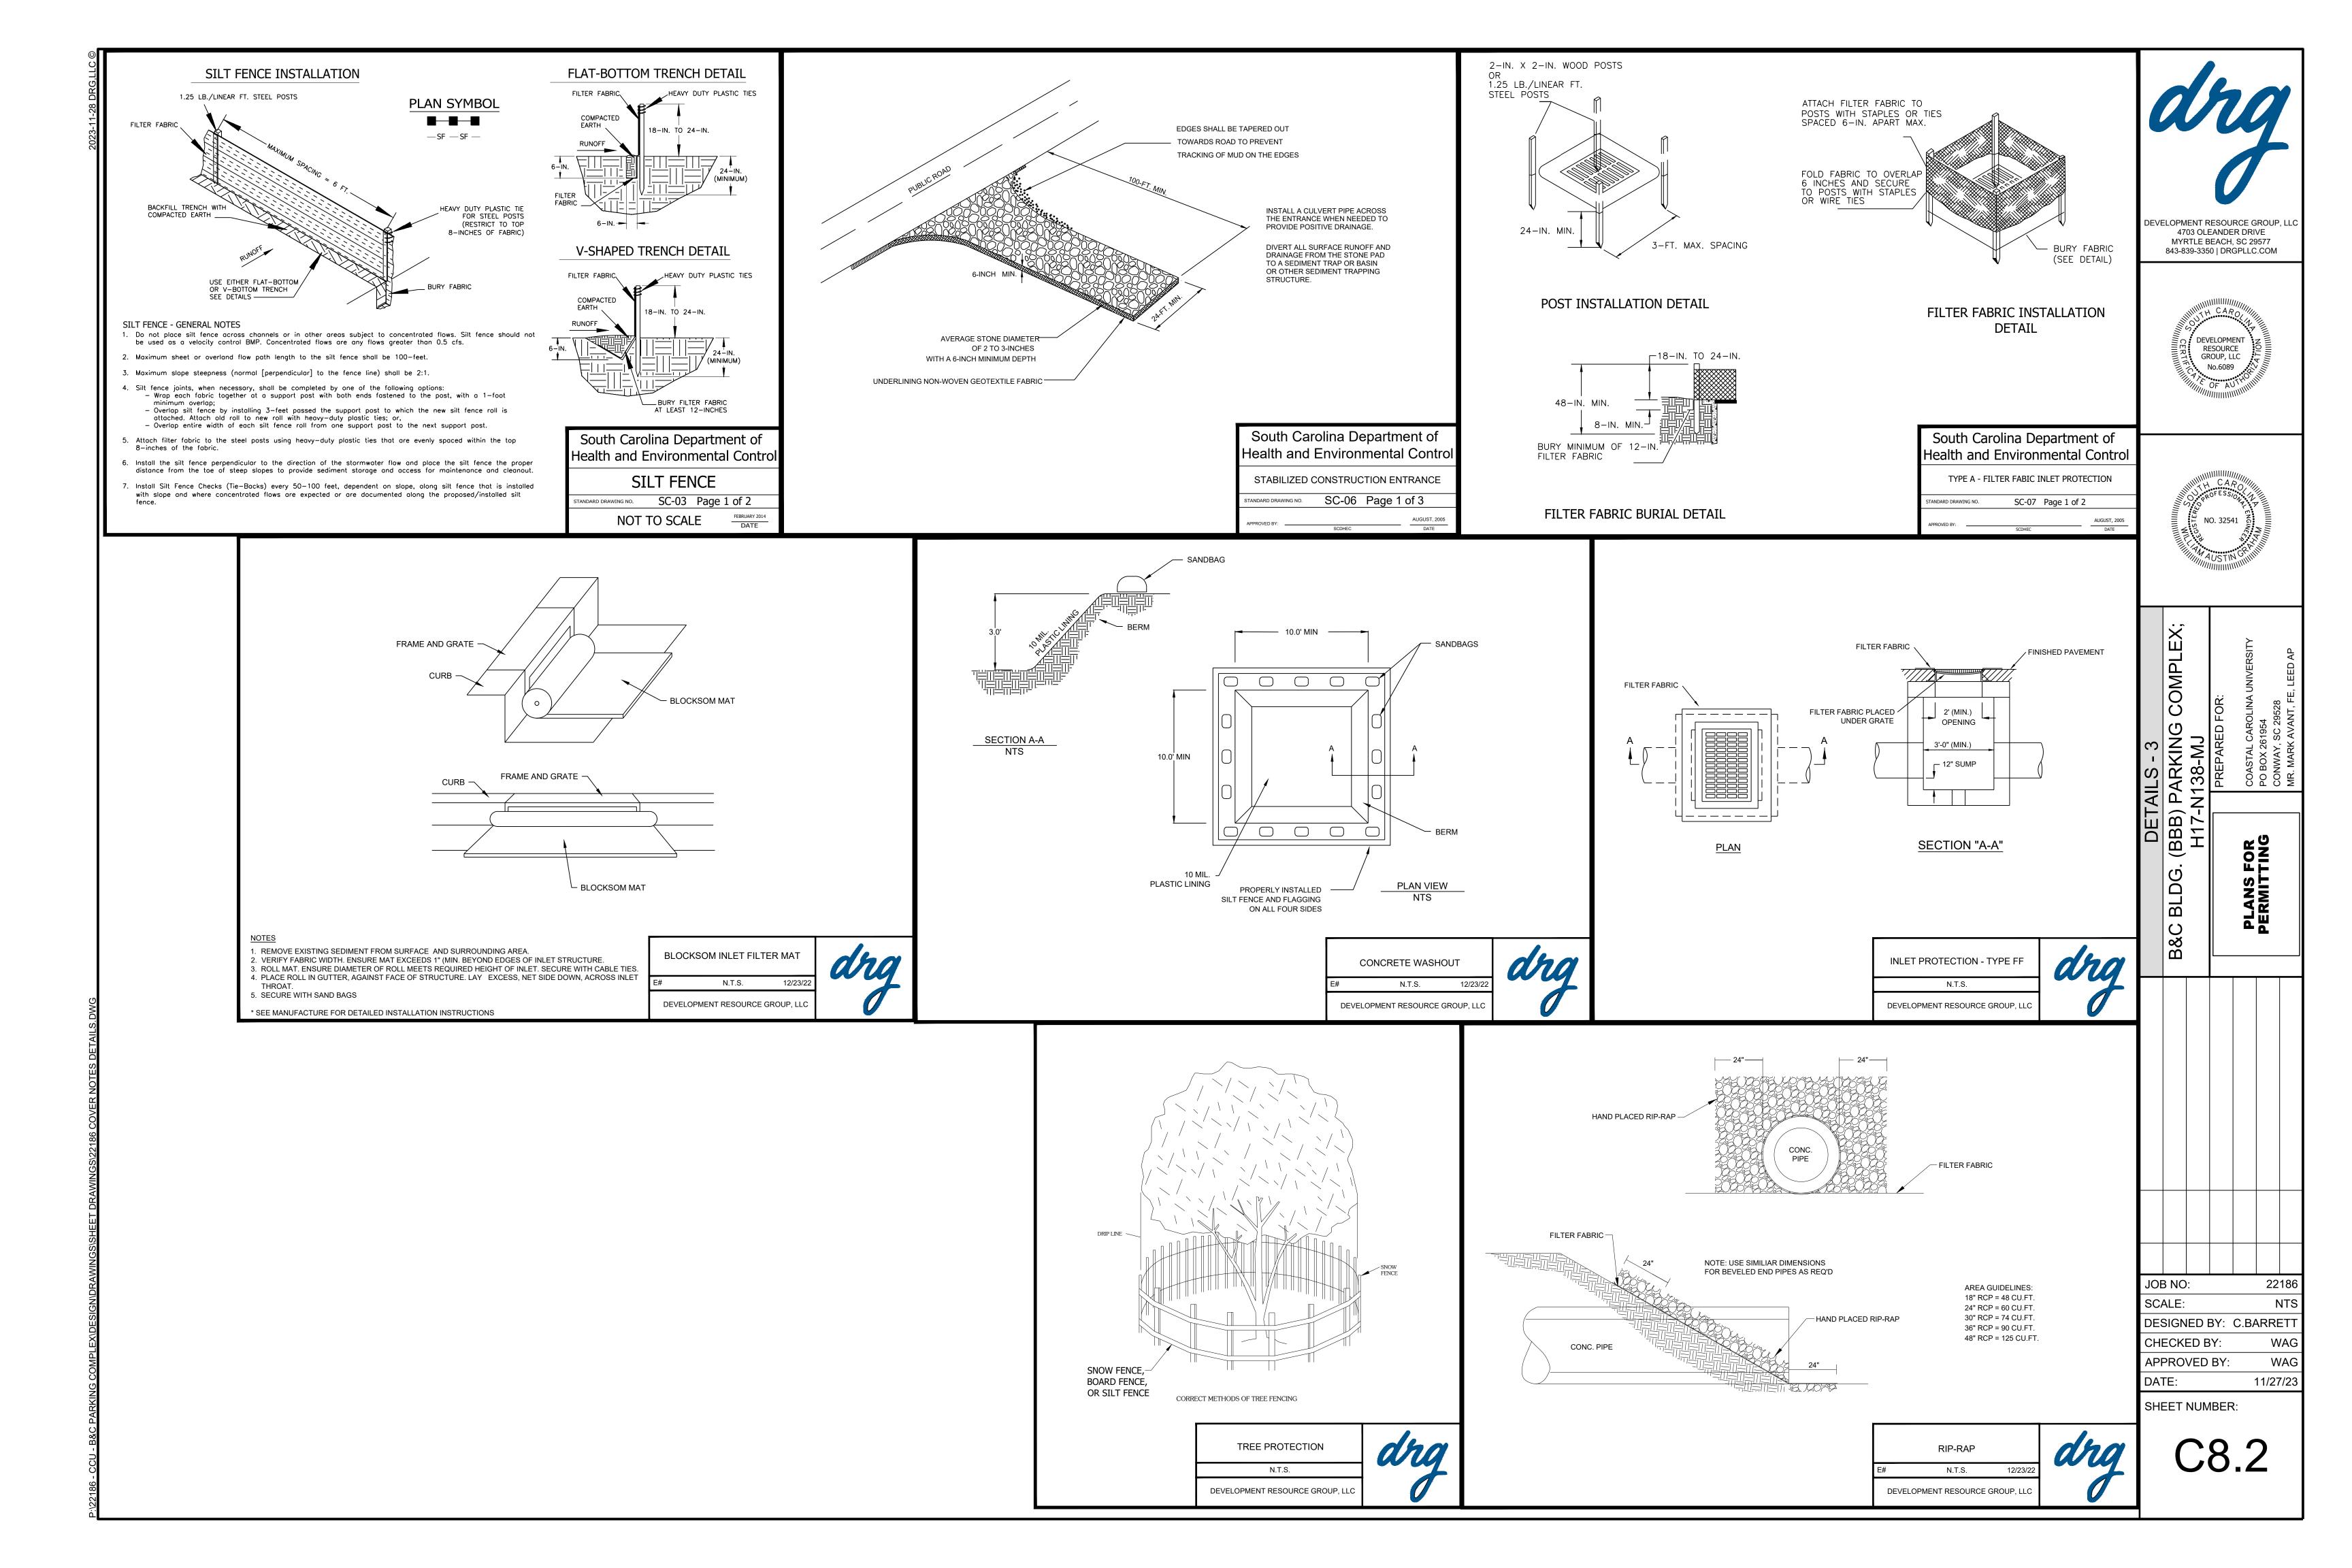

- 1. REFERENCE SITE WORK AND SPECIFICATIONS FOR INFORMATION NEEDED FOR LANDSCAPE WORK.
- 2. CONTRACTOR TO VERIFY AND LOCATE ALL PROPOSED AND EXISTING STRUCTURES. NOTIFY LANDSCAPE ARCHITECT OR DESIGNATED REPRESENTATIVE FOR ANY LAYOUT DISCREPANCIES OR ANY CONDITION THAT WOULD PROHIBIT THE INSTALLATION AS SHOWN.
- 3. CONTRACTOR SHALL CALL 811 TO VERIFY AND LOCATE ANY AND ALL UTILITIES ON SITE PRIOR TO COMMENCING WORK. LANDSCAPE ARCHITECT SHOULD BE NOTIFIED OF ANY CONFLICTS.
- 4. QUANTITIES ON THESE PLANS ARE FOR REFERENCE ONLY.
- 5. THE SPACING OF PLANTS SHOULD BE AS INDICATED ON PLANS OR OTHERWISE NOTED. ALL TREES AND SHRUBS SHALL BE PLANTED PER DETAILS.
- 6. A MINIMUM OF 2% SLOPE SHALL BE PROVIDED AWAY FROM ALL STRUCTURES.
- 7. LANDSCAPE ISLANDS SHALL BE CROWNED, AND UNIFORM THROUGHOUT THE SITE.
- 8. ALL PLANTING AREAS SHALL BE GRADED SMOOTH TO ACHIEVE FINAL CONTOURS AS INDICATED ON PLAN WITH 3" OF TOPSOIL AND 3" OF COMPOST AND CONSISTENTLY BLENDED TO A DEPTH OF 9". ALL BEDS SHALL BE CROWNED TO ANTICIPATE SETTLEMENT AND ENSURE PROPER DRAINAGE.
- 9. PLANTING AREAS AND SOD TO BE SEPARATED BY "V-NOTCH" AS PER DETAILS.
- 10. MULCH SHALL BE INSTALLED AT 1/2" BELOW THE TOPS OF SIDEWALKS AND CURBING.
- 11. CONTAINER GROWN PLANT MATERIAL IS PREFERRED UNLESS INDICATED ON THE PLANT QUANTITIES. BALL AND BURLAP PLANT MATERIAL CAN BE SUBSTITUTED IF NEED BE AND IS APPROPRIATE TO THE SIZE AND QUALITY INDICATED ON THE PLANT MATERIAL LIST.
- 12. TREES SHALL BE PLANTED AT A MINIMUM OF 5' FROM ANY UTILITY LINE, SIDEWALK OR CURB. TREES SHALL ALSO BE 10' CLEAR FROM FIRE HYDRANTS.
- 13. 4" OF TRIPLE GROUND DARK HARDWOOD MULCH (2" SETTLED THICKNESS) SHALL BE PLACED IN ALL LANDSCAPE BEDS AFTER PLANTING IS COMPLETED.
- 14. CONTRACTOR TO PROVIDE UNIT PRICING OF LANDSCAPE MATERIALS AND BE RESPONSIBLE FOR OBTAINING ALL LANDSCAPE AND IRRIGATION PERMITS.
- 15. HEIGHT AND CALIPER SIZE SUPERSEDE GALLON SIZE AT THE TIME OF PLANTING.

#### <u>IRRIGATION</u>

- 1. IN THE ABSENCE OF AN IRRIGATION SYSTEM OR AREAS BEYOND THE COVERAGE LIMITS OF A PERMANENT IRRIGATION SYSTEM, CONTRACTOR SHALL WATER SOD TEMPORARILY, BY ANY MEANS AVAILABLE, TO DEVELOP ADEQUATE GROWTH. TURF SHALL BE IN 100% ESTABLISHMENT AT THE TIME OF ACCEPTANCE BY OWNER.
- 2. HOSE BIB WITHIN 50' OF LANDSCAPE MATERIAL IN THE ABSENCE OF A MECHANICAL IRRIGATION SYSTEM.

#### MAINTENANCE REQUIREMENTS:


- 1. VEGETATION SHOULD BE INSPECTED REGULARLY TO ENSURE THAT PLANT MATERIAL IS ESTABLISHING PROPERLY AND REMAINS IN A HEALTHY GROWING CONDITION APPROPRIATE FOR THE SEASON. IF DAMAGED OR REMOVED, PLANTS MUST BE REPLACED BY A SIMILAR VARIETY AND SIZE.
- 2. PLANT MATERIAL SHALL BE GUARANTEED FOR ONE YEAR FOLLOWING THE ACCEPTANCE BY OWNING. SHOULD PLANT MATERIAL FAIL DURING THAT WARRANTY PERIOD THE OWNER MAY REQUEST FOR THE ONE-TIME REPLACEMENT.
- 3. MOWING, TRIMMING, EDGING AND SUPERVISION OF WATER APPLICATIONS SHALL BE THE RESPONSIBILITY OF THE CONTRACTOR UNTIL THE OWNER OR OWNER'S REPRESENTATIVE ACCEPTS AND ASSUMES REGULAR MAINTENANCE.
- 4. ALL LANDSCAPE AREAS SHOULD BE CLEANED AND KEPT FREE OF TRASH, DEBRIS, WEEDS AND OTHER MATERIAL.


#### **GENERAL TURF NOTES**

- 1. THE CONTRACTOR IS RESPONSIBLE FOR MAINTAINING TOP SOIL AT THE CORRECT GRADES. CONTRACTOR TO FINE GRADE AREAS TO REACH FINAL CONTOURS AS SPECIFIED PER CIVIL PLANS. ALL CONTOURS SHOULD ACHIEVE POSITIVE DRAINAGE AWAY FROM BUILDINGS AND STRUCTURES. WATER SHOULD NOT BE ABLE TO POOL IN ANY AREAS UNLESS SPECIFIED OTHERWISE. EROSION CONTROL FABRIC TO BE USED WHERE NECESSARY TO PREVENT SOIL EROSION.
- 2. ANY LOSS OF TOPSOIL OR TURF DUE TO EROSION IS THE RESPONSIBILITY OF THE CONTRACTOR UNTIL IT IS 100% ESTABLISHED.
- 3. CONTRACTOR TO REMOVE ANY ROCKS 3/4" AND LARGER, STICKS AND DEBRIS PRIOR TO INSTALLATION OF TOPSOIL AND SOD.
- 4. FOUR (4") OF TOPSOIL SHALL BE APPLIED TO AREAS DISTURBED BY CONSTRUCTION RECEIVING SOD. IF TOPSOIL IS NOT AVAILABLE ON SITE, THE CONTRACTOR SHALL PROVIDE TOPSOIL AS APPROVED BY THE OWNER OR OWNERS REPRESENTATIVE.
- 5. TOPSOIL SHALL BE FRIABLE, NATURAL LOAM, FREE OF ROCKS, WEEDS, BRUSH, CLAY LUMPS, ROOTS, TWIGS, LITTER AND ENVIRONMENTAL CONTAMINANTS.
- . CONTRACTOR SHALL BE RESPONSIBLE FOR SOD UNTIL ACCEPTANCE. THIS SHALL INCLUDE, BUT NOT BE LIMITED TO: MOWING, WATERING, WEEDING, CULTIVATING, CLEANING AND REPLACING DEAD OR BARE AREAS TO KEEP PLANTS IN A VIGOROUS, HEALTHY CONDITION. SOD SHALL BE REPLACED IF NECESSARY.
- 7. CENTIPEDE / BERMUDA SOD SHALL BE PLACED ALONG ALL IMPERVIOUS EDGES, AT A MINIMUM. THIS SHALL INCLUDE CURBS, WALKS, INLETS, MANHOLES AND PLANTING BED AREAS. SOD SHALL COVER OTHER AREAS COMPLETELY AS INDICATED BY PLAN.
- 8. SOD SHALL BE STRONGLY ROOTED DROUGHT RESISTANT SOD, FRESHLY CUT, FREE OF WEEDS AND UNDESIRABLE NATIVE GRASS AND MACHINE CUT TO PAD THICKNESS OF 3/4" (+1/4"), EXCLUDING TOP GROWTH AND THATCH. PROVIDE ONLY SOD CAPABLE OF VIGOROUS GROWTH AND DEVELOPMENT WHEN PLANTED.
- 9. LAY SOD WITH TIGHTLY FITTING JOINTS, NO OVERLAPS WITH STAGGERED STRIPS TO OFFSET JOINTS.
- 10. SOD SHALL BE ROLLED TO CREATE A SMOOTH EVEN SURFACE. SOD SHOULD BE WATERED THOROUGHLY DURING INSTALLATION PROCESS.
- 11. SHOULD INSTALLATION OCCUR BETWEEN OCTOBER 1ST AND MARCH 1ST, SOD SHALL INCLUDE AN OVER-SEED OF ANNUAL RYE OR WINTER RYEGRASS AT A RATE OF FOUR POUNDS PER ONE THOUSAND SQUARE FEET FOR


## LIGHTING NOTES

- 1. LIGHT FIXTURES SHALL BE FULL-CUTOFF AND MEET ILLUMINATING ENGINEERING SOCIETY OF NORTH AMERICA (IESNA) CRITERIA.
- 2. LIGHTING SHALL BE AIMED STRAIGHT DOWN.
- 3. PARKING LOT LIGHTING SHALL HAVE LIGHTING NO GREATER THAN SIXTEEN FEET IN HEIGHT.

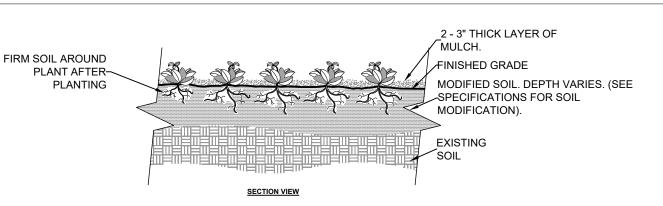


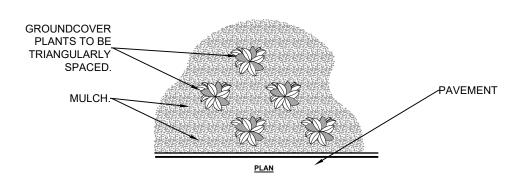

5. GROUND COVER PLANTING DETIAL

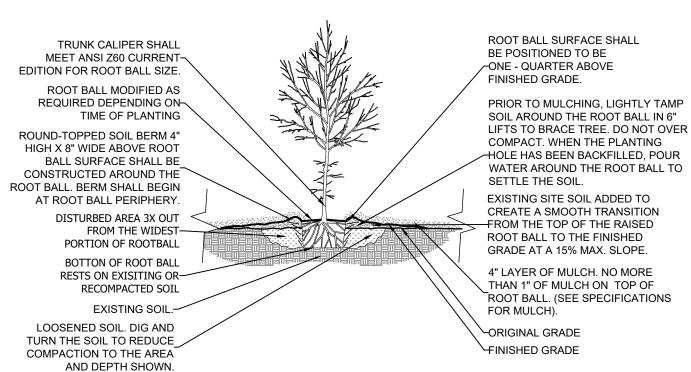


2. SHRUB PLANTING DETAIL

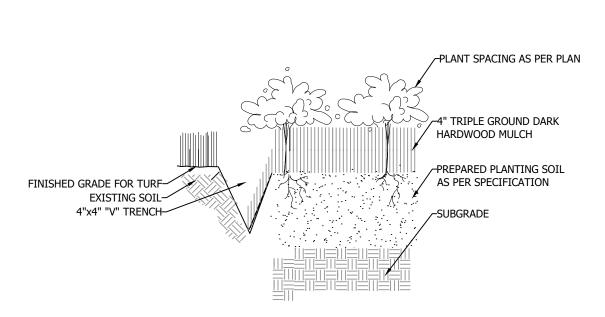




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# 1. TREE PLANTING DETAIL 3. BED EDGING DETAIL

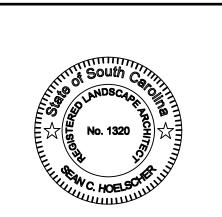

4. TREE STAKING DETAIL

	11110 DE	. 17 (12)	11 111				
PLANT	SCHEE	ULE					
<u>SYMBOL</u>	<u>CODE</u>	BOTANICAL / COMMON NAME	<u>SIZE</u>	CONTAINER	QTY	<u>DETAIL</u>	<u>REMARKS</u>
TREES	LAG MUS	Lagerstroemia indica x fauriei 'Muskogee' / Muskogee Crape Myrtle	5` Ht.	Pot	9		Multi-Trunk Specimen
	LAG NAT	Lagerstroemia indica x fauriei 'Natchez' / Natchez Crape Myrtle	5` Ht.	Pot	9		Multi-Trunk Specimer
	NYS SYL	Nyssa sylvatica / Tupelo	10` HT 2" CAL	Pot	10		
	QUE LYR	Quercus lyrata / Overcup Oak	10` Ht.	Pot	13		
<u>EVERGREEN</u>	TREES						
	MAG BRK	Magnolia grandiflora 'Brackens Brown Beauty' / Bracken's Beauty Southern Magnolia	10` HT 2" CAL	Pot	4		Canopy
	MAG LIT	Magnolia grandiflora 'Little Gem' / Little Gem Dwarf Southern Magnolia	5` Ht.	Pot	14		Understory
	PIN ELL	Pinus elliottii / Slash Pine	10` HT 2" CAL	Pot	13		Canopy
	QUE LAU	Quercus laurifolia / Laurel-leaved Oak	10` HT 2" CAL	Pot	13		Canopy
	CUP LEY	x Cupressocyparis leylandii / Leyland Cypress	10` HT 2" CAL	Pot	7		Canopy
SHRUBS.							
$\langle \cdot \rangle$	FEI VEU	Feijoa sellowiana / Pineapple Guava	18" Ht.	Pot	54		
3	LIR BIG	Liriope muscari 'Big Blue' / Big Blue Lilyturf	18" Ht.	Pot	126		
$\overline{}$	MYR CER	Myrica cerifera / Wax Myrtle	18" Ht.	Pot	61		
$\overline{}$	PIT TOB	Pittosporum tobira / Japanese Pittosporum	18" Ht.	Pot	75		
	RHO FOR	Rhododendron indicum 'Pink Formosa' / Pink Formosa Indica Azalea	18" Ht.	Pot	41		
£±3	ROS RAD	Rosa x 'Radrazz' / Knock Out® Shrub Rose	18" Ht.	Pot	50		

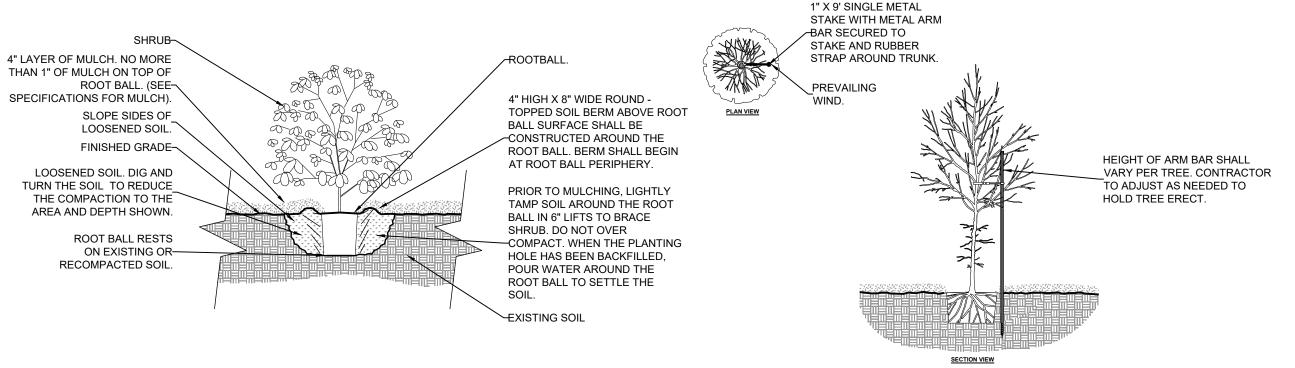B&C BLDG. (BBB) PARKING COMPLEX;
H17-N138-MJ
PLANS FOR

COASTAL CAROLINA UNIVERSITY
PERMITTING
PO BOX 261954

JOB NO: 22186
SCALE: NTS
DESIGNED BY: SCH
CHECKED BY: SCH
APPROVED BY: WAG

SHEET NUMBER:

DATE:

L2

11/27/23